





## **PROPOSED CHILDCARE CENTRE**

PROJECT REF. NO. #186



#### **ACOUSTIC RECOMMENDATIONS:**

ACOUSTIC RECOMMENDATIONS TO BE READ IN CONJUNCTION WITH PROPOSED CHILDCARE CENTRE - DA ACOUSTIC ASSESSMENT PREPARED BY RENZO TONIN & ASSOCIATES REPORT REF NO. TN562-01F01 REV 2 DATED 7th JUNE, 2024

#### 7. RECOMMENDATIONS

The proposed boundary fence along the northern, southern and western boundaries, shall be at least 1.8m above around level (at any point)

- The fence shall be constructed from any impervious material such as lapped and capped timber, corrugated sheet steel, a transparent sold material (e.g., glass or 'Perspex'), masonry or a combination of these

- They must not contain any acoustically untreated holes or gaps, including beneath the fences at the base

- In most cases the minimum surface density of the boundary fence should be  $15 \text{kg/m}^2$ .

Additionally acoustic screens are also required around the ground floor external play areas. - The section of screen illustrated in pink shall comprise of a 1m high vertical barrier and 1.1m barrier

cantilevered inwards towards the play area, at an anale of approx, 63°. - The section of screen illustrated in orange shall comprise of a 1 m high vertical barrier and 1.3m barrier cantilevered inwards towards the play area, at an angle of approx. 51°.

- The cantilevered screens can be constructed from a transparent sold material (e.g., glass or (Perspex))

- They must not contain any acoustically untreated holes or gaps, including beneath the fences at the base and shall have a minimum surface density of at least 15ka/m<sup>2</sup>

Acoustic screens are also required along the frontages of the first-floor external play area. Perspex screens shall extend at least 1.44m above the masonry wall i.e. to RL 52.00 (illusatrated in yellow).

All façade glazing and light-weight external wall and roof systems shall shall comply with the minimum specifications detailed in 5.2.

- The proposed sliding doors for the playrooms are remain open during indoor play.

- All doors and windows shall be closed in the event of a music performance.

#### NAPPY CHANGE NCC REQUIREMENTS - CLAUSE F4D4 (9)(C)

G) A CLASS 9B EARLY CHILDHOOD CENTRE MUST BE PROVIDED WITH-

(II) ONE BATH, SHOWER OR SHOWER-BATH; AND

(III) IF THE CENTRE ACCOMMODATES CHILDREN YOUNGER THAN 3 YEARS OLD-

(A) A LAUNDRY FACILITY COMPRISING A WASHTUB AND SPACE IN THE SAME ROOM FOR A WASHING MACHINE; AND

(B) A BENCH TYPE BABY BATH, WHICH IS WITHIN 1 M OF THE NAPPY CHANGE BENCH; AND

(C) A NAPPY CHANGING BENCH WHICH-

(AA) IS WITHIN 1 M OF SEPARATE ADULT HAND WASHING FACILITIES AND BENCH TYPE BABY BATH; AND

(BB) MUST BE NOT LESS THAN 0.9 M<sup>2</sup> IN AREA AND AT A HEIGHT OF NOT LESS THAN 850 MM, BUT NOT MORE THAN 900 MM ABOVE THE FINISHED FLOOR LEVEL; AND

(CC) MUST HAVE A SPACE NOT LESS THAN 800 MM HIGH, 500 MM WIDE AND 800 MM DEEP FOR THE STORAGE OF STEPS; AND

(DD) IS POSITIONED TO PERMIT A STAFF MEMBER CHANGING A NAPPY TO HAVE VISIBILITY OF THE PLAY AREA AT ALL TIMES.

NATIONAL CONSTRUCTION CODE 2022 F4D4 FACILITIES IN CLASS 3 TO 9 BUILDINGS

NAPPY CHANGE TABLE (NCT) TO BE DONE IN ACCORDANCE WITH NCC F4D4 (9) (C) (III) (A-D)

#### **CHILD CARE FACILITES - NCC CLAUSE F4D4**

THE FOLLOWING FACILITIES ARE REQUIRED TO CHILDCARE CENTRES:

A KITCHEN WITH SINK, SEPARATE HAND WASHING FACILITIES, SPACE FOR A FRIDGE AND COOKING FACILITIES

AS THE CENTRE CATERS FOR CHILDREN <5, THE KITCHEN MUST HAVE A GATE OR DOOR THAT IS CHILD PROOF (1.5m LATCHING)

#### AS THE CENTRE CATERS FOR CHILDREN <2, THE KITCHEN MUST FACILITATE SUPERVISION **OF THOSE CHILDREN**

#### ONE BATH, SHOWER OR SHOWER/BATH

AS THE CENTRE ACCOMMODATE CHILDREN <3 A LAUNDRY FACILITY COMPRISING OF A WASHTUB AND SPACE FOR A WASHING MACHINE IN THE SAME ROOM IS REQUIRED

AS THE CENTRE ACCOMMODATES CHILDREN < 3 A BENCH-TYPE BABY BATH WHICH IS WITHIN 1M OF A NAPPY CHANGE TABLE IS REQUIRED

AS THE CENTRE ACCOMMODATES CHILDREN < 3, A NAPPY CHANGING BENCH THAT IS WITHIN 1M OF AN ADULT HAND WASH BASIN, BE AT LEAST 0.9m<sup>2</sup>, 850-900mm HIGH AND MUST HAVE A SPACE NO LESS THAN 800mm(H) X 500mm(W) X 800mm(D) FOR THE STORAGE OF STEPS AND BE POSITIONED TO ALLOW SUPERVISION OF THE PLAY AREA AT ALL TIMES

SLIP RESISTANCE (IN ACCORDANCE WITH NCC TABLE D3D15 & SPECIFICATION 27)

- STAIRS TREADS OR LANDING SURFACE DRY P3 OR R10 OR WET P4 OR R11
- STAIR COLOUR CONTRAST NOSING DRY P3 OR WET P4 2.
- RAMPS STEEPER THAN 1:14 GRADIENT DRY P4 PR R11 OR WET P5 OR R12 .3
- RAMPS STEEPER THAN 1:20 BUT NOT STEEPER THAN 1:14 GRADIENT DRY P3 OR R10 OR 4. WET P4 OR R11
- WET AREAS (AS TOILETS, SHOWER OR SIMILAR) P3 OR R10 5.
- DRY AREA R9 6.



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PROJECT NO .:

#### FITOUT OF FOOD PREMISES.

#### GENERAL REQUIREMENTS

PROOF AGAINST PESTS. COOKING APPLIANCES EXCEEDING A TOTAL MAX. POWER INPUT OF 8kW FOR 2. ELECTRICAL, OR A TOTAL GAS INPUT OF 29Mi/h FOR A GAS APPLIANCE ARE REQUIRED TO HAVE A KITCHEN EXHAUST SYSTEM INSTALLED IN ACCORDANCE WITH CLAUSE F6D12 OF NCC AND A\$1668, PARTS 1 & 2. HOT WATER SERVICES TO BE POSITIONED 75 MM CLEAR 3. HEATED WATER IN ACCORDANCE WITH AS 3500.4.2 4. 5. WALL OF ALL FOOD PREMISES SHALL BE OF SOLID CONSTRUCTION. CERAMIC FLOOR TILES SHALL BE CLEANABLE, NON-ABSORBENT, EPOXY GROUTED AND 6. LAID IN ACCORDANCE WITH AS 3958.1 THE INTERSECTION OF FLOORS WITH WALLS SHALL MEET THE COVING REQUIREMENT. 7 8. COVING TILE MINIMUM RADIUS TO BE 25mm. 9. WALLS AND CEILINGS SHALL BE OF SOLID CONSTRUCTION. CEILINGS SHALL BE NON-PERFORATED AND FINISHED FREE OF OPEN JOINS, CRACKS 10. AND CREVICES.

- 11 12.
- 1.3
- 14.

#### SERVICES:

CEILING.

SHALL BE FIXED ON BRACKERS WITH 25mm CLERANCE BETWEEN PIPE AND WALL SURFACE.

ALL PENETRATIONS SHALL BE SEALED.

FIXTURES SHALL BE MOVABLE FOR CLEANING.

REFER TO MECHANICAL CONSULTANTS DRAWINGS FOR ALL VENTILATION DETAILS

OF WASTE WATER.

REFER TO ELECTRICAL CONSULTANTS DRAWINGS FOR ALL ELECTRICAL DETAILS

HAND WASHING (40°C) CLEAN POTABLE WATER.

PROVIDE A TOWEL AND SOAP DISPENSER.

A RECEPTACLE FOR USED TOWELS SHALL BE PROVIDED.

#### **ACOUSTIC RECOMMENDATIONS**







AMENDMENTS:

#### **KITCHEN - GENERAL NOTES:**

FITOUT OF KITCHEN TO BE IN ACCORDANCE WITH AS 4674-2004 DESIGN, CONSTRUCTION AND

WALL AND CEILING SHALL BE TIGHT JOINTED, SEALED AND DUST PROOF. SEALANTS USED SHALL BE WASHABLE AND OF IMPERVIOUS MATERIAL. WALL AND CEILINGS ARE TO BE OF LIGHT COLOUR. ALL SHELVING TO BE 25mm OFF WALL.

SERVICE PIPE CONDUITS AND WIRING SHALL BE CONCEALED IN FLOOR PLINTHS, WALLS AND

REFER TO HYDRAULIC CONSULTANTS DRAWINGS FOR AL HYDRAULIC DETAILS AND DISPOSAL

HAND BASINS ARE TO BE FREE STANDING AND PROVIDED WITH A SINGLE OUTLET FOR WARM

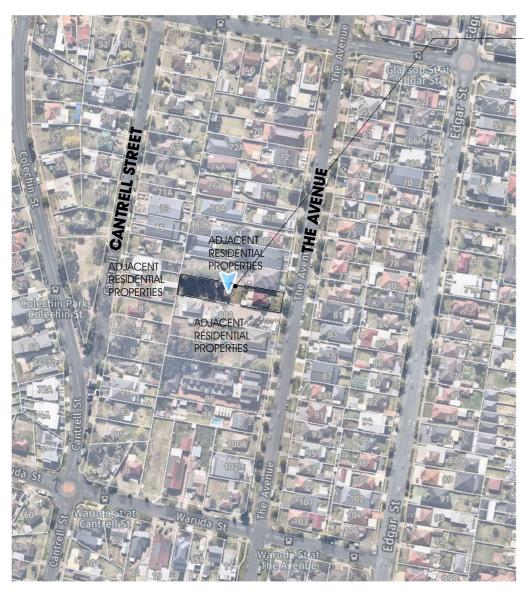
1.44m HIGH ACOUSTIC BARRIER

1.52m HIGH ACOUSTIC BARRIER - 1.0 VERTICAL BARRIER WITH 1.1m CANTILEVERED INWARDS AT 63° ANGLE

1.84m HIGH ACOUSTIC BARRIER 1.0m VERTICAL BARRIER WITH 1.3m CANTILIVERED INWARDS AT 51° ANGLE

#### FOR DEVELOPMENT APPLICATION

ENTITY 8886



## **LOCATION PLAN**

SCALE 1:2000 (A3)

Sheet List			
Sheet			Revision
Number	Sheet Name	Revision	Date
DA 00	Notes	E	03.07.24
DA 01	Location Plan	E	03.07.24
DA 02	Site Analysis	E	03.07.24
DA 03	Site Plan	E	03.07.24
DA 04	Demolition, Erosion & Sediment Control Plan	E	03.07.24
DA 05	Key Plans	E	03.07.24
DA 06	Basement Part Plan A	E	03.07.24
DA 07	Basement Part Plan B	E	03.07.24
DA 08	Ground Floor Part Plan A	E	03.07.24
DA 09	Ground Floor Part Plan B	E	03.07.24
DA 10	First Floor Plan	E	03.07.24
DA 11	Roof Part Plan A	E	03.07.24
DA 12	Roof Part Plan B	E	03.07.24
27.1.2		-	50107

SUBJECT SITE	
NO.86 THE AVENUE, BANKSTOWN NSW	
LOT 47, SEC A, DP 110163	3
SITE AREA: 1195 m <sup>2</sup>	
	w.R

#### **DEVELOPMENT DATA**

SITE ADDRESS

SITE AREA ZONE TOTAL BUILDING AREA GFA (MAX.478m2) FSR

#### TOTAL NO. OF PLACEMENTS

CARPARKING **REQUIRED SPACES 68/4** 

PROVIDED SPACES

#### PARKING SCHEDULE

STAFF VISITOR VISITOR ACCESSIBLE

TOTAL CARPARKING SPACES

	Sheet List				
Revision Date	Sheet Number	Sheet Name	Revision	Revision Date	
03.07.24	DA 25	Basement Evacuation Plan	E	03.07.24	
03.07.24	DA 26	Ground Floor Evacuation Plan	E	03.07.24	
03.07.24	DA 27	First Floor Evacuation Plan	E	03.07.24	
03.07.24	DA 28	Shadow Diagrams	E	03.07.24	
03.07.24	DA 29	Shadow Diagrams	E	03.07.24	
03.07.24	DA 30	Shadow Diagrams	E	03.07.24	
03.07.24	DA 31	Shadow Diagrams	E	03.07.24	
03.07.24	DA 32	Shadow Diagrams	E	03.07.24	
03.07.24	DA 33	Shadow Diagrams	E	03.07.24	
03.07.24	DA 34	Acoustic Fence Details	E	03.07.24	
03.07.24	DA 35	Notification Plan	E	03.07.24	
03.07.24					



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Sheet List

Number Sheet Name

North Elevation Part A

North Elevation Part B

South Elevation Part A

South Elevation Part B

GFA Calculation Plan

Playspace Area plan

West Elevation

Section A

Section A

Section B

Section B

East & Streetscape Elevation

Sheet

DA 13

DA 14

DA 15

DA 16

DA 17

DA 18

DA 19

DA 20

DA 21

DA 22

DA 23

DA 24

AMENDMENTS:

03.07.24

PROJECT NO .:

#186 DA 01

Revision

F

F

F

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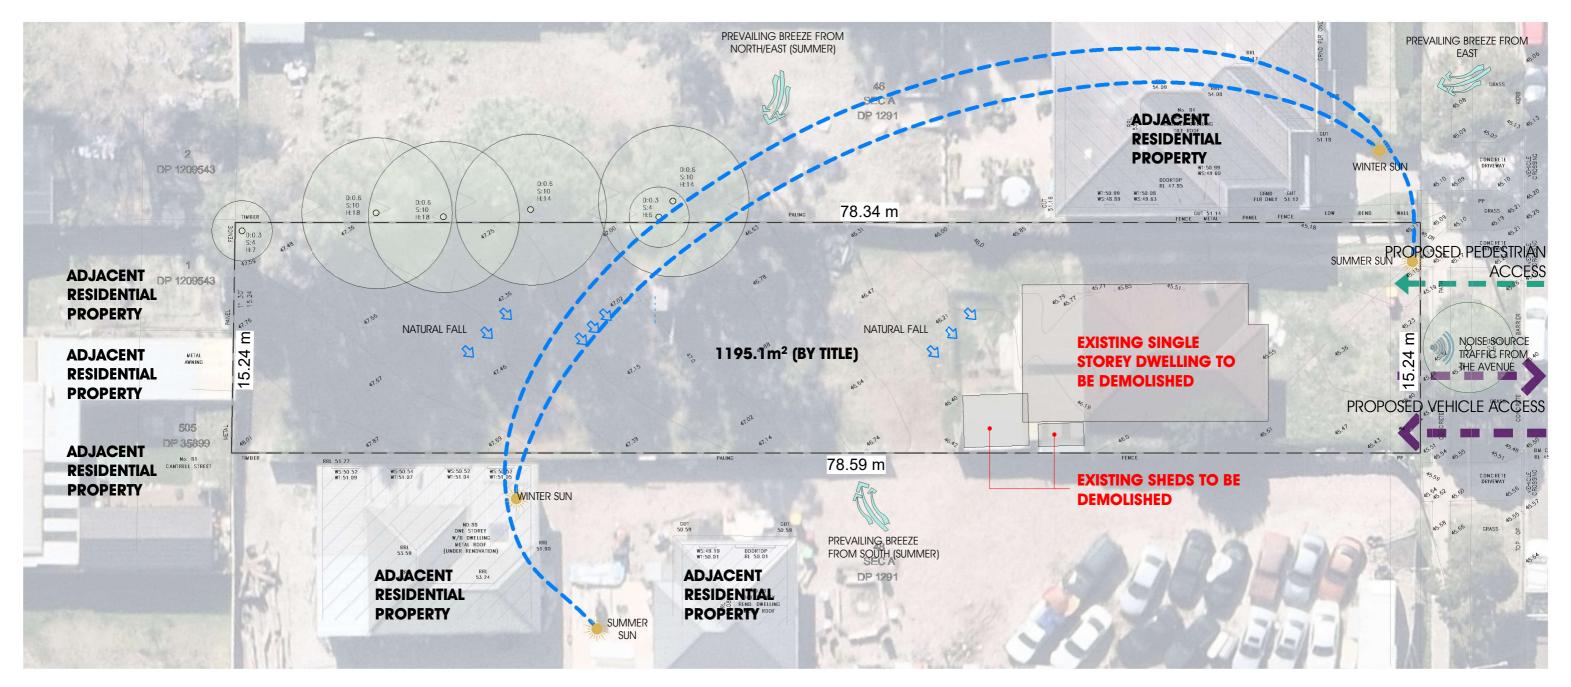
68 CHILDREN
0.37:1
447.1m2
379.0m2
<b>R2 LOW DENSITY RESIDENTIAL</b>
1195.1 m2 (BY TITLE)
AVENUE, BANKSTOWN NSW 2200
LOT 47, SEC. A, DP110163, 86 THE

17
1
8
8 8
17
17

#### FOR DEVELOPMENT APPLICATION

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PROPOSED CHILDCARE CENTRE



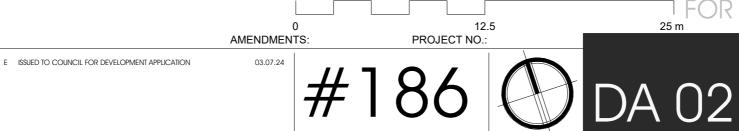
#### SITE ANALYSIS PLAN

SCALE 1 : 250 (A3)



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PROPOSED CHILDCARE CENTRE

#### **DEVELOPMENT DATA**

PROVIDED SPACES

SITE ADDRESS	LOT 47, SEC. A, DP110163, 86 THE AVENUE, BANKSTOWN NSW 2200
SITE AREA	1195.1 m2 (BY TITLE)
ZONE	<b>R2 LOW DENSITY RESIDENTIAL</b>
TOTAL BUILDING AREA	379.0m2
GFA (MAX.478m2)	447.1m2
FSR	0.37:1
TOTAL NO. OF PLACEMENTS	68 CHILDREN
CARPARKING	
REQUIRED SPACES 68/4	17

GROSS	FLOOR	AREA
-------	-------	------

BASEMENT	
SHED	4.9E ~~?
0.120	4.85 m <sup>2</sup>
LNDRY	10.40 m <sup>2</sup>
GROUND FLOOR	
GROUND FLOOR	280.58 m <sup>2</sup>
SHED	2.50 m <sup>2</sup>
WSA	8.45 m <sup>2</sup>
FIRST FLOOR	
FIRST FLOOR A	72.98 m <sup>2</sup>
FIRST FLOOR B	67.32 m <sup>2</sup>
TOTAL GFA	447.10 m <sup>2</sup>

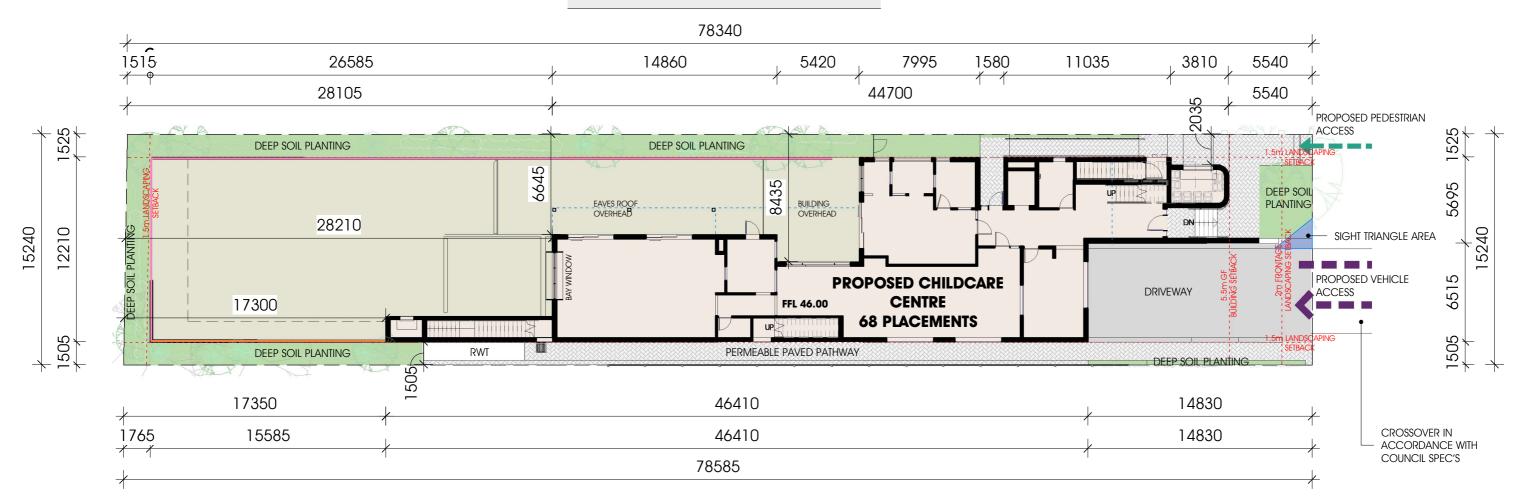
#### **INTERNAL PLAYSPACE AR**

Name	Comments
PLAYROOM 01	8 - 0-2 YO
PLAYROOM 02	20 - 3-6 YO
PLAYROOM 03	20 - 3-6 YO
PLAYROOM 04	20 - 2-3YO
UNENCUMBERED INDOOR	
PLAYROOM 04	

#### **EXTERNAL PLAYSPACE CALCS.**

17

EXT. PLAY AREA 03	75m2
EXT. PLAY AREA 02	376m2
EXT. PLAY AREA 01	41m2



#### **SITE PLAN**



REA SCHEDU	JLE		
Area Required	Area Provided	Staff Ratio	No. of Staff
26	26.79 m <sup>2</sup>	1:4	2
65	70.23 m <sup>2</sup>	1:10	2
65	66.87 m <sup>2</sup>	1:10	2
65	53.33 m <sup>2</sup>	1:5	4
	12.69 m <sup>2</sup>		
221	229.92 m <sup>2</sup>		10

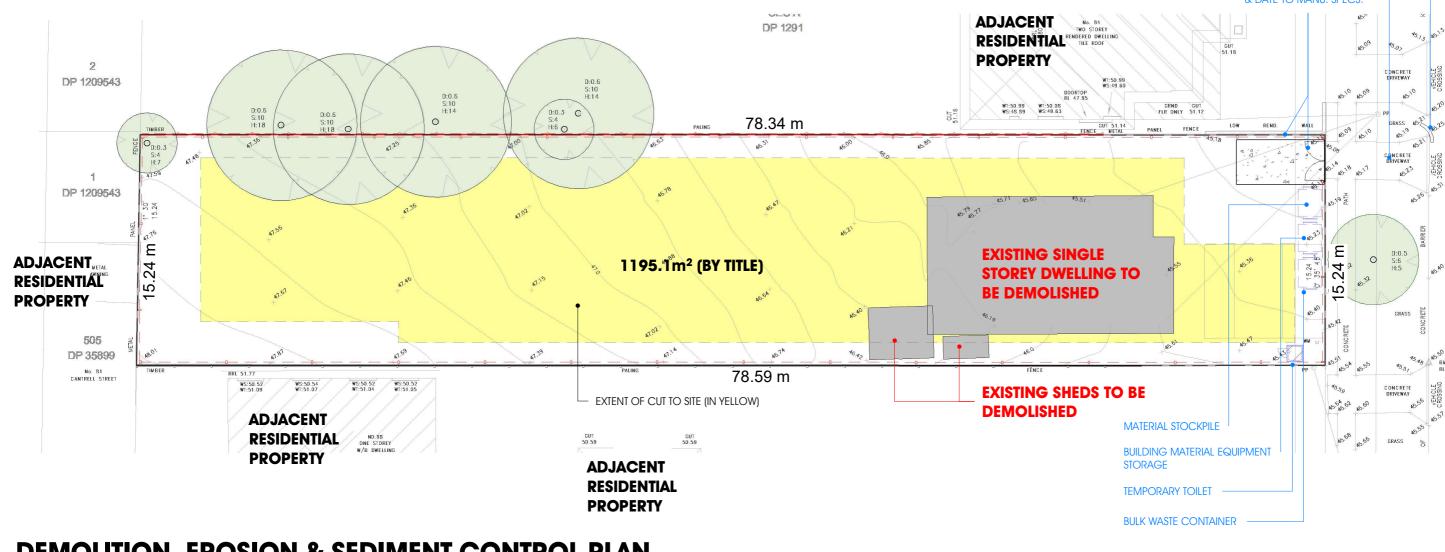
#### **ACOUSTIC RECOMMENDATIONS**

- 1.44m HIGH ACOUSTIC BARRIER
- 1.52m HIGH ACOUSTIC BARRIER 1.0 VERTICAL BARRIER WITH 1.1m CANTILEVERED INWARDS AT 63° ANGLE
- 1.84m HIGH ACOUSTIC BARRIER -1.0m VERTICAL BARRIER WITH 1.3m CANTILIVERED INWARDS AT 51° ANGLE

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### **DEMOLITION, EROSION & SEDIMENT CONTROL PLAN**



#### SEDIMENT CONTROL NOTES

1. ALL EROSION AND SEDIMENTATION CONTROL MEASURES, INCLUDING REVEGETATION AND STORAGE OF SOIL AND TOPSOIL, SHALL BE IMPLEMENTED TO THE STANDARDS OF THE SOIL CONSERVATION OF NSW.

2. ALL DRAINAGE WORKS SHALL BE CONSTRUCTED AND STABILIZED AS EARLY AS POSSIBLE DURING

3. SEDIMENT TRAPS SHALL BE CONSTRUCTED AROUND ALL INLET PITS. CONSISTING OF 300MM WIDE X

4. ALL SEDIMENT BASINS AND TRAPS SHALL BE CLEANED WHEN THE STRUCTURES ARE A MAXIMUM OF 60 % FULL OF SOIL MATERIALS, INCLUDING THE MAINTENANCE PERIOD.

5. ALL DISTURBED AREAS SHALL BE REVEGITATED AS SOON AS THE RELEVANT WORKS ARE COMPLETED. SOIL AND TOPSOIL STOCKPILES SHALL BE LOCATED AWAY FROM

6. DRAINAGE LINES AND AREA WHERE WATER MAY CONCENTRATE

7. FILTER SHALL BE CONSTRUCTED BY STRETCHING A FILTER FABRIC (PROPEX OR APPROVED EQUIVALENT BETWEEN POST AT 3.0M CENTRES. FABRIC SHALL BE BURIED 150MM ALONG ITS LOWER EDGE.

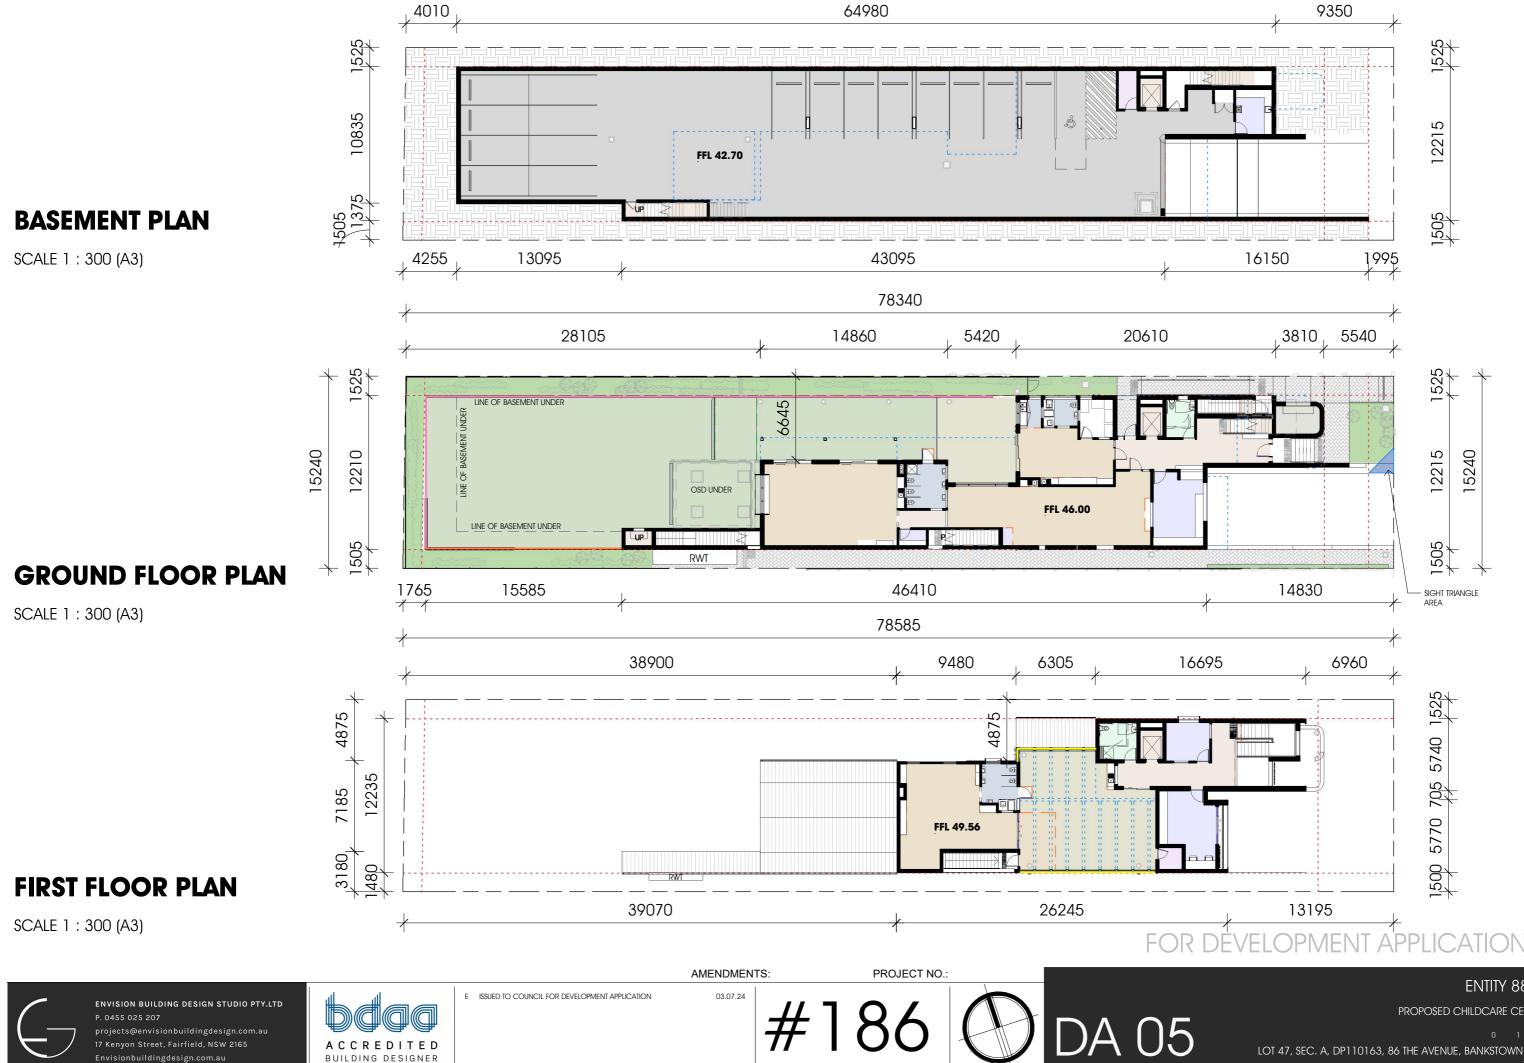
#### SEDIMENT KERB INLET SEDIMENTATION TRAP

EXISTING VEHICULAR CROSSING TO BE MADE REDUNDANT



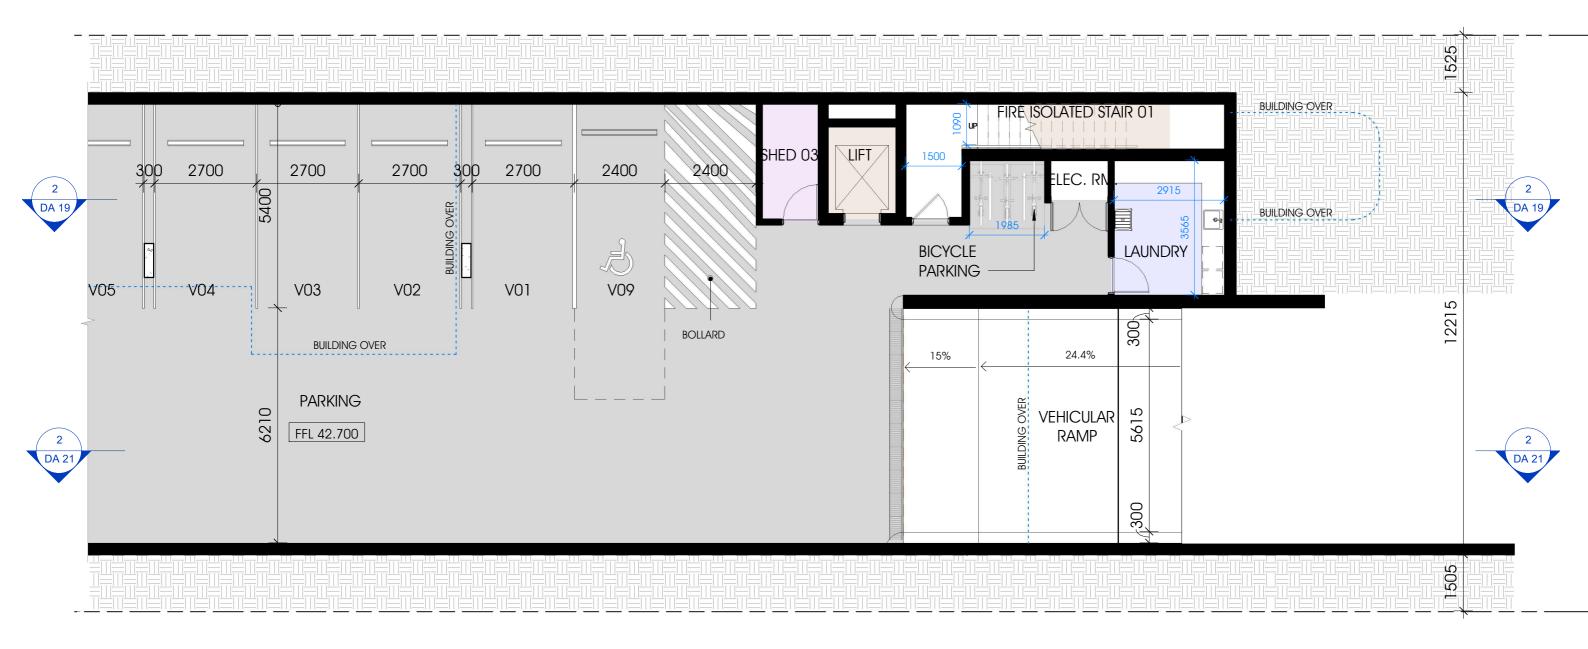
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# PARKING SCHEDULESTAFF8VISITOR8VISITOR ACCESSIBLE1TOTAL CARPARKING SPACES17



#### **BASEMENT PLAN**



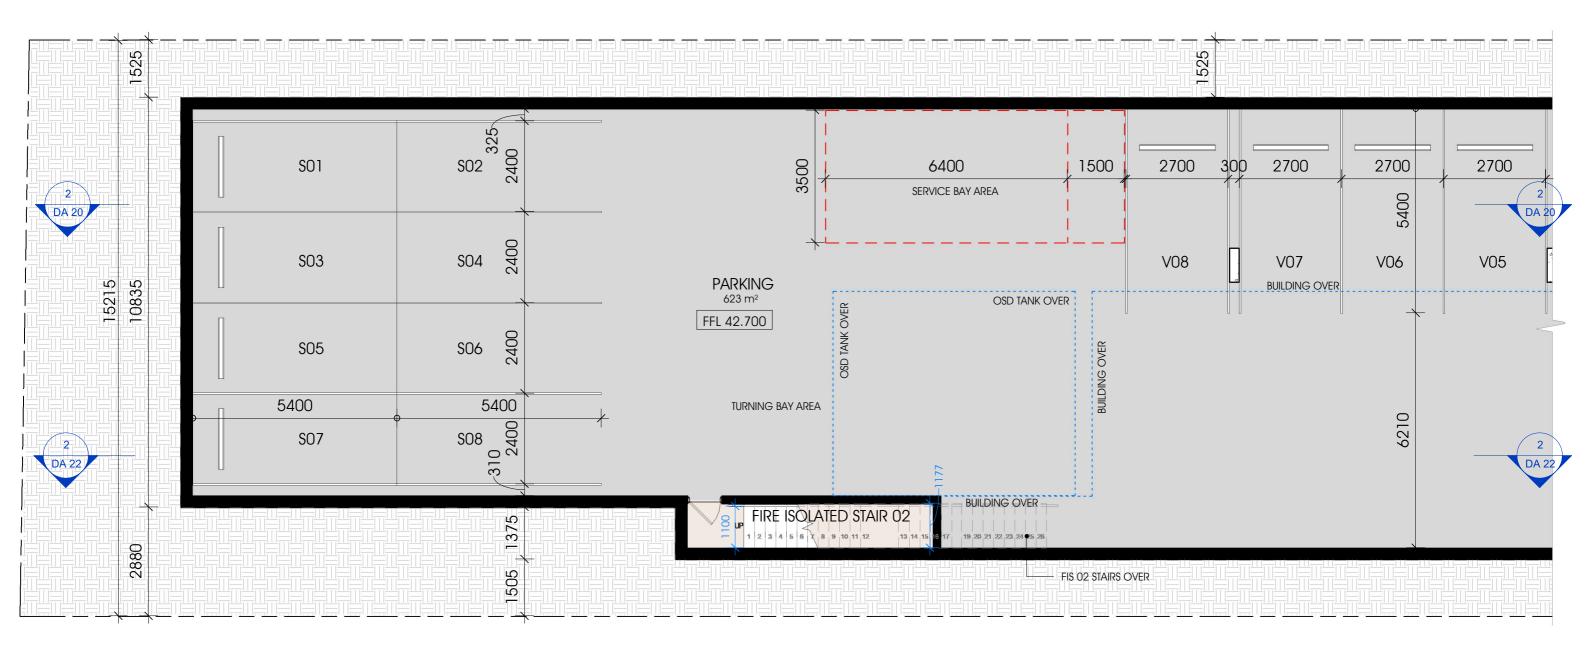
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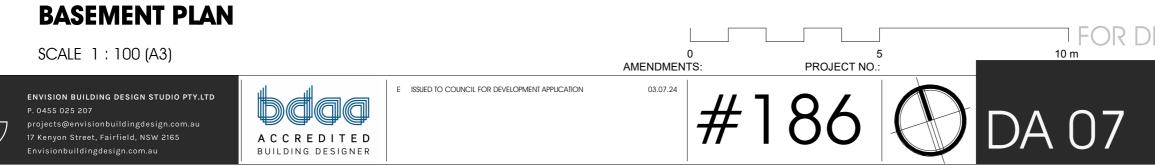
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PROPOSED CHILDCARE CENTRE

#### **PARKING SCHEDULE**

STAFF VISITOR	8
VISITOR ACCESSIBLE	1
TOTAL CARPARKING SPACES	17

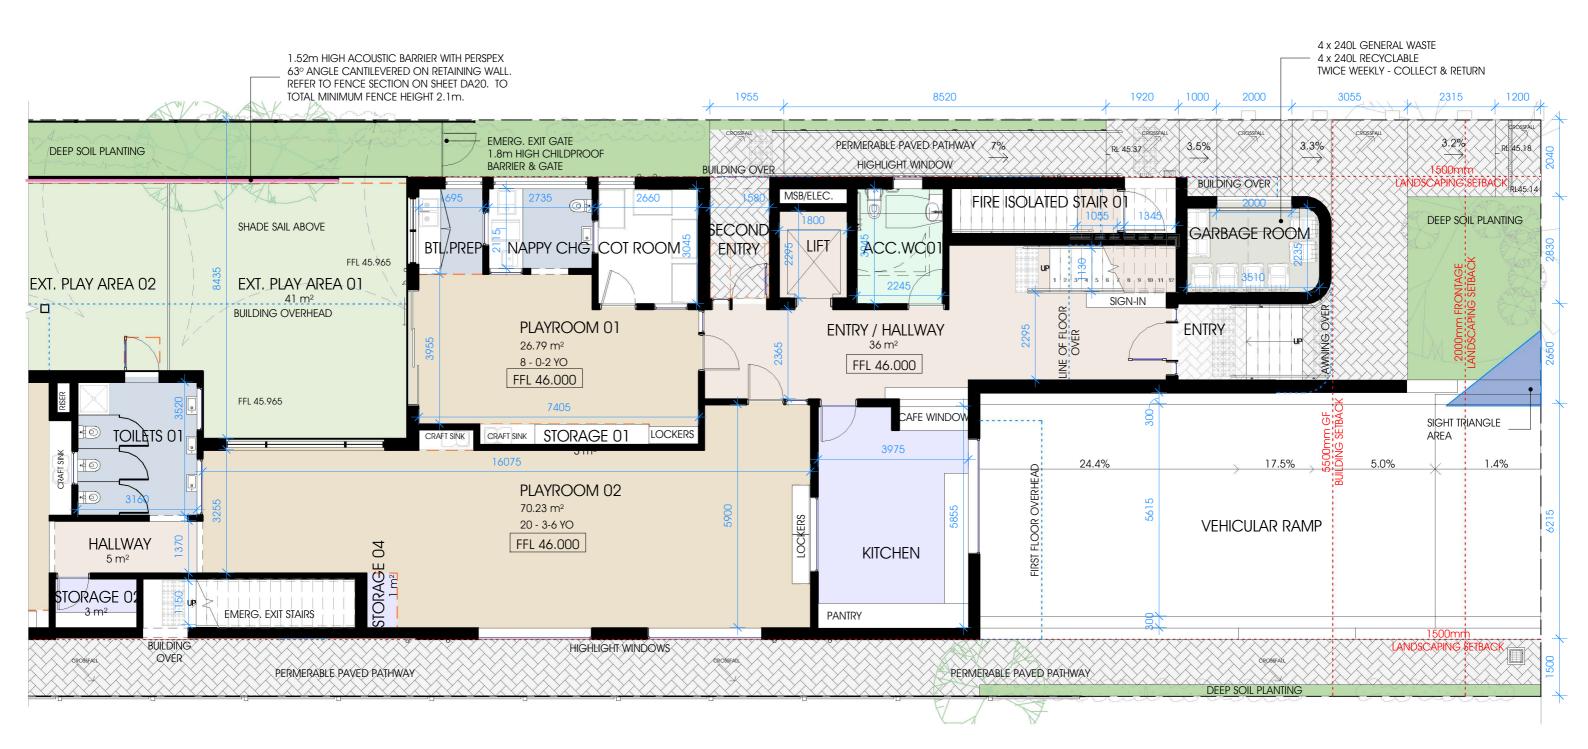




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PROPOSED CHILDCARE CENTRE



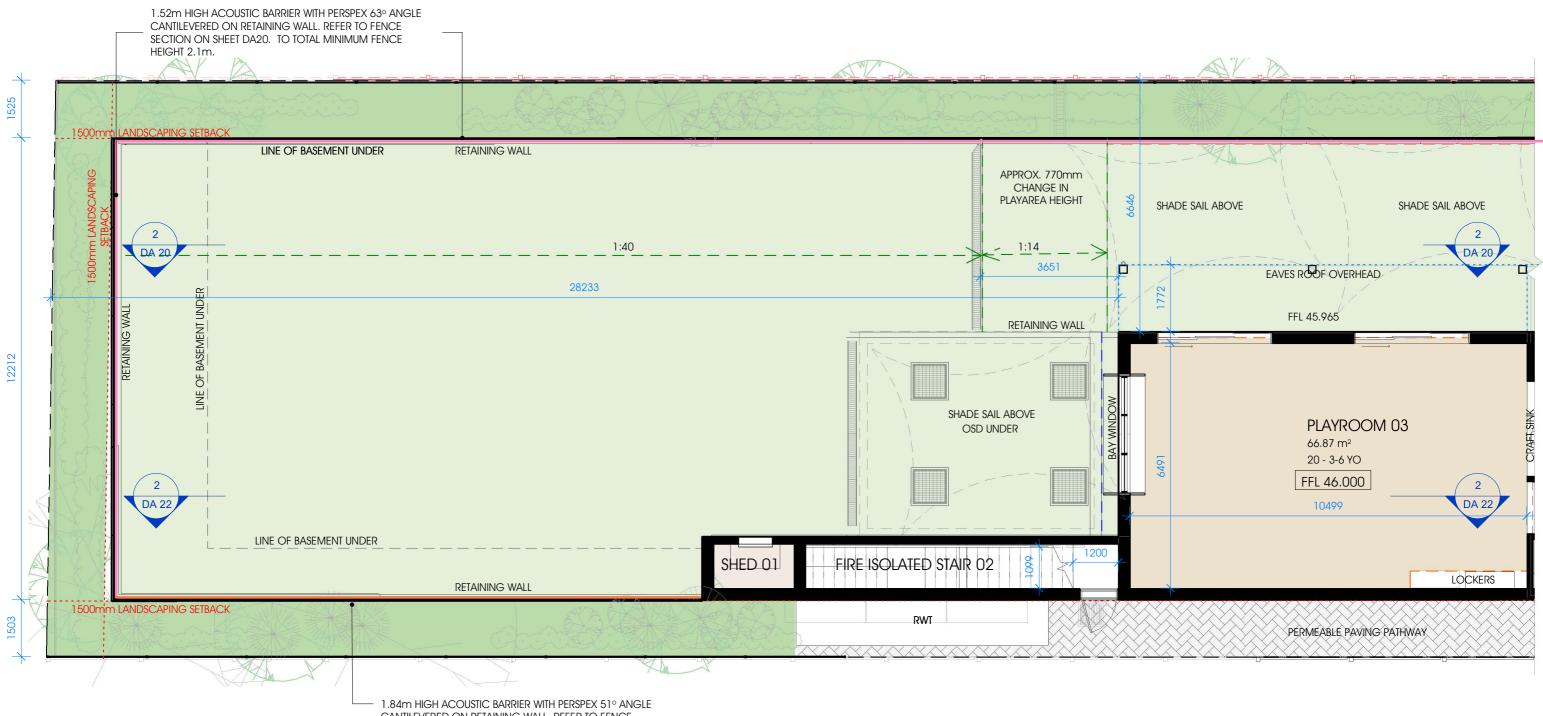
## **GROUND FLOOR PLAN**



## FOR DEVELOPMENT APPLICATION

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PROPOSED CHILDCARE CENTRE



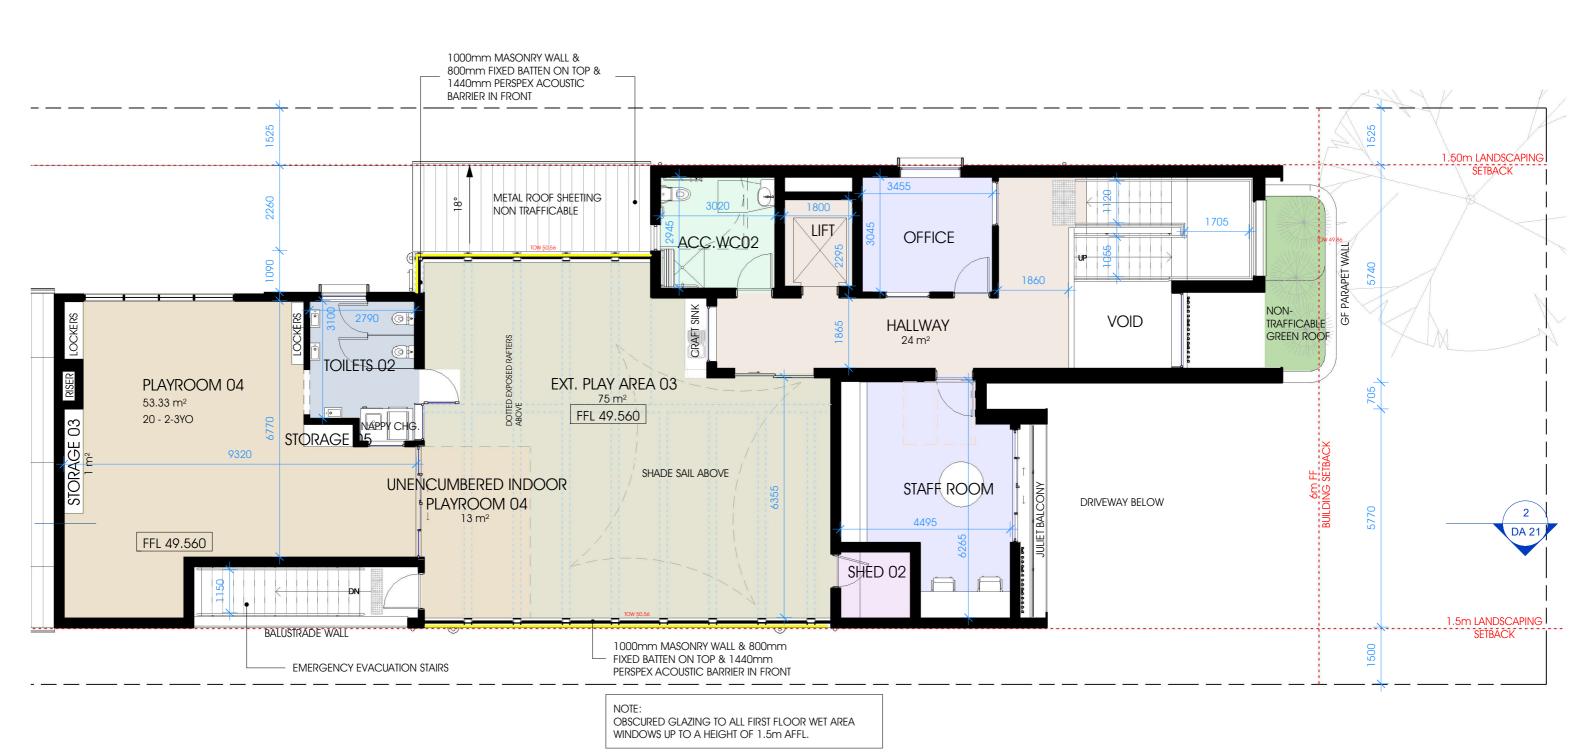
CANTILEVERED ON RETAINING WALL, REFER TO FENCE SECTION ON SHEET DA20. TO TOTAL MINIMUM FENCE HEIGHT 2.1m.

## **GROUND FLOOR PLAN**



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## FIRST FLOOR PLAN

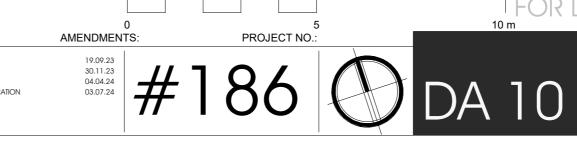
#### SCALE 1:100 (A3)



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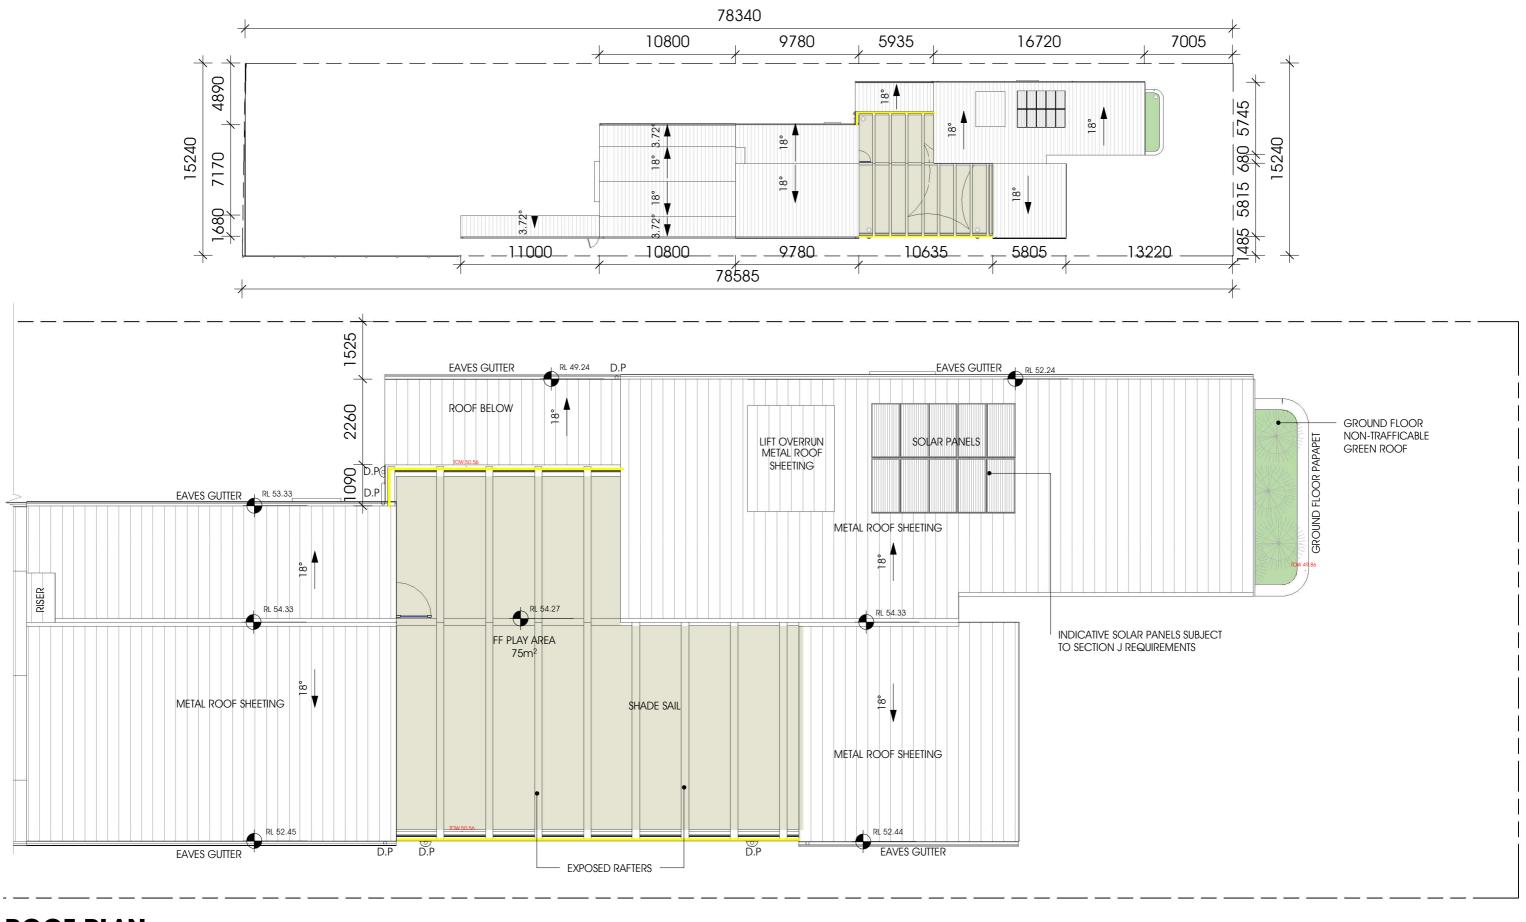
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#### FOR DEVELOPMENT APPLICATION

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PROPOSED CHILDCARE CENTRE



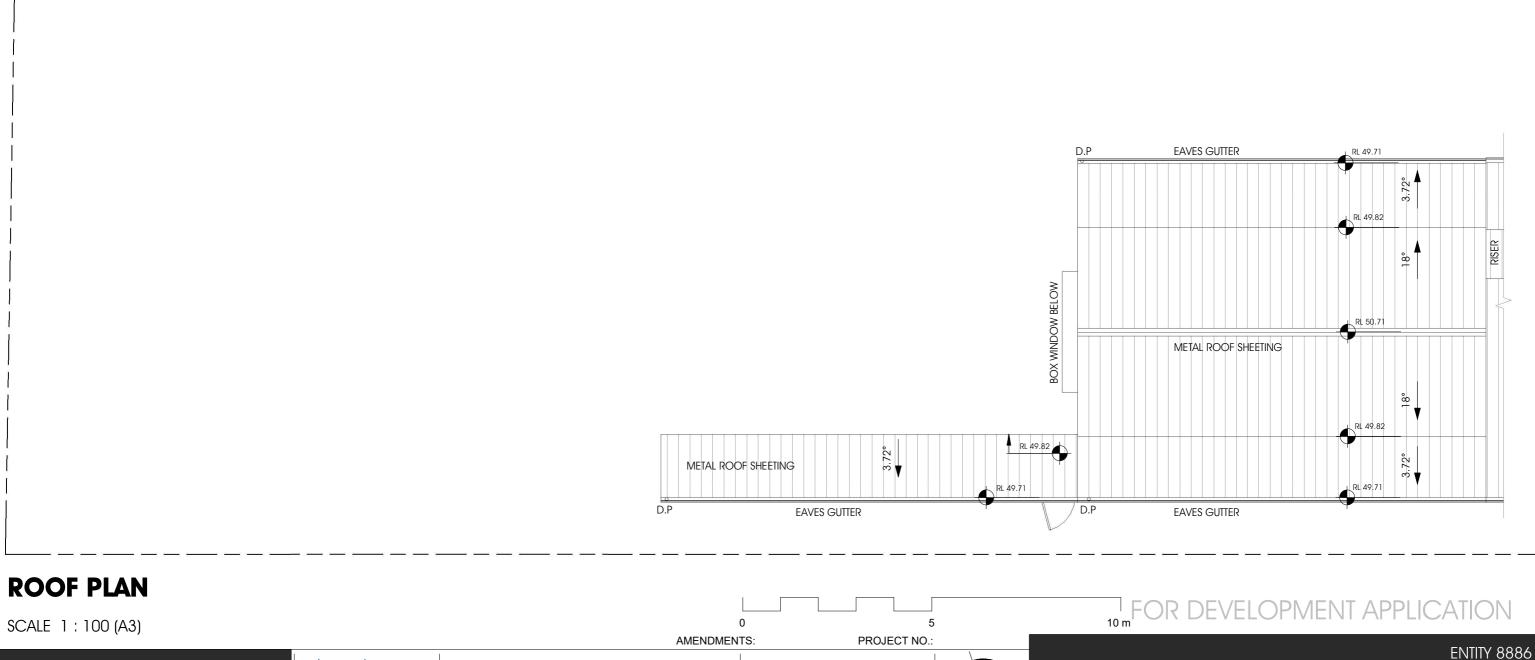
## **ROOF PLAN**



## FOR DEVELOPMENT APPLICATION

#### ENTITY 8886

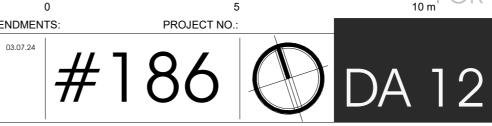
PROPOSED CHILDCARE CENTRE

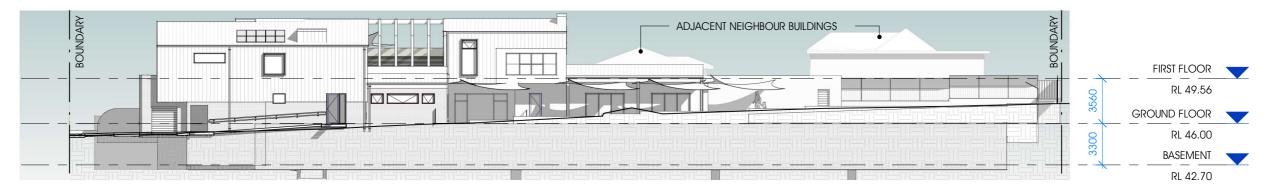




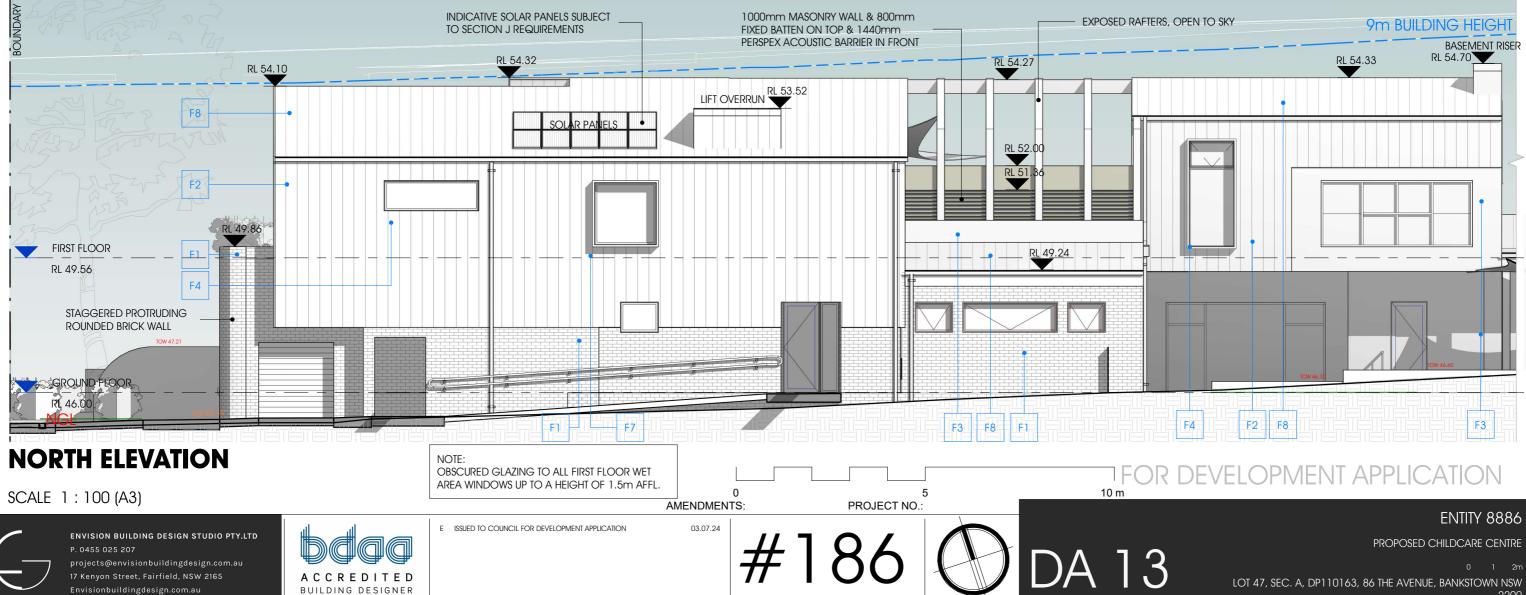
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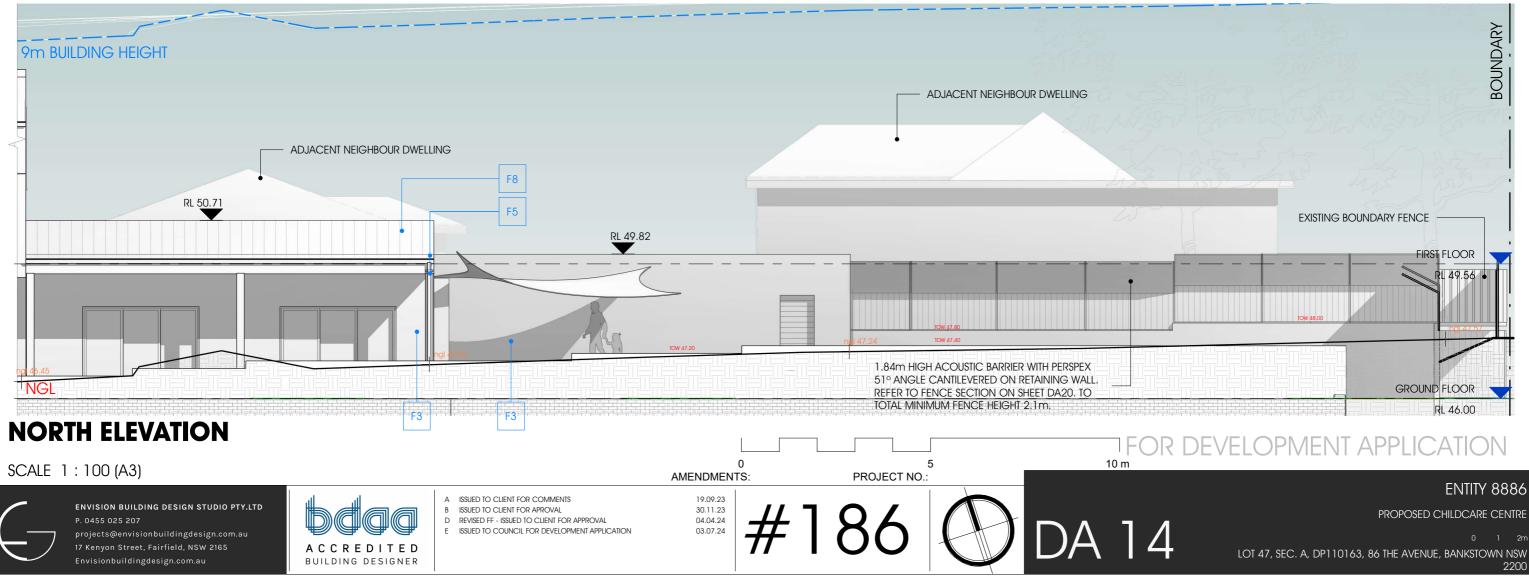






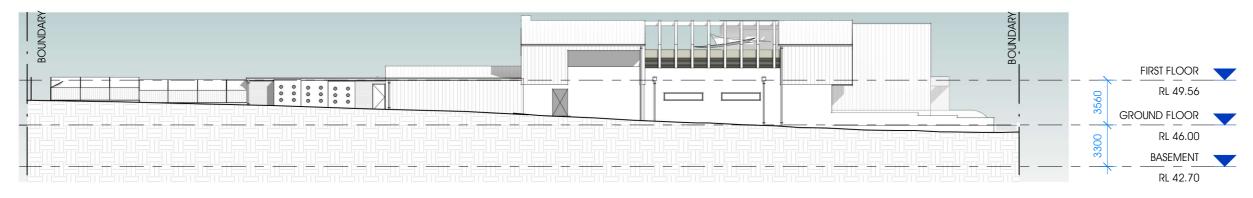
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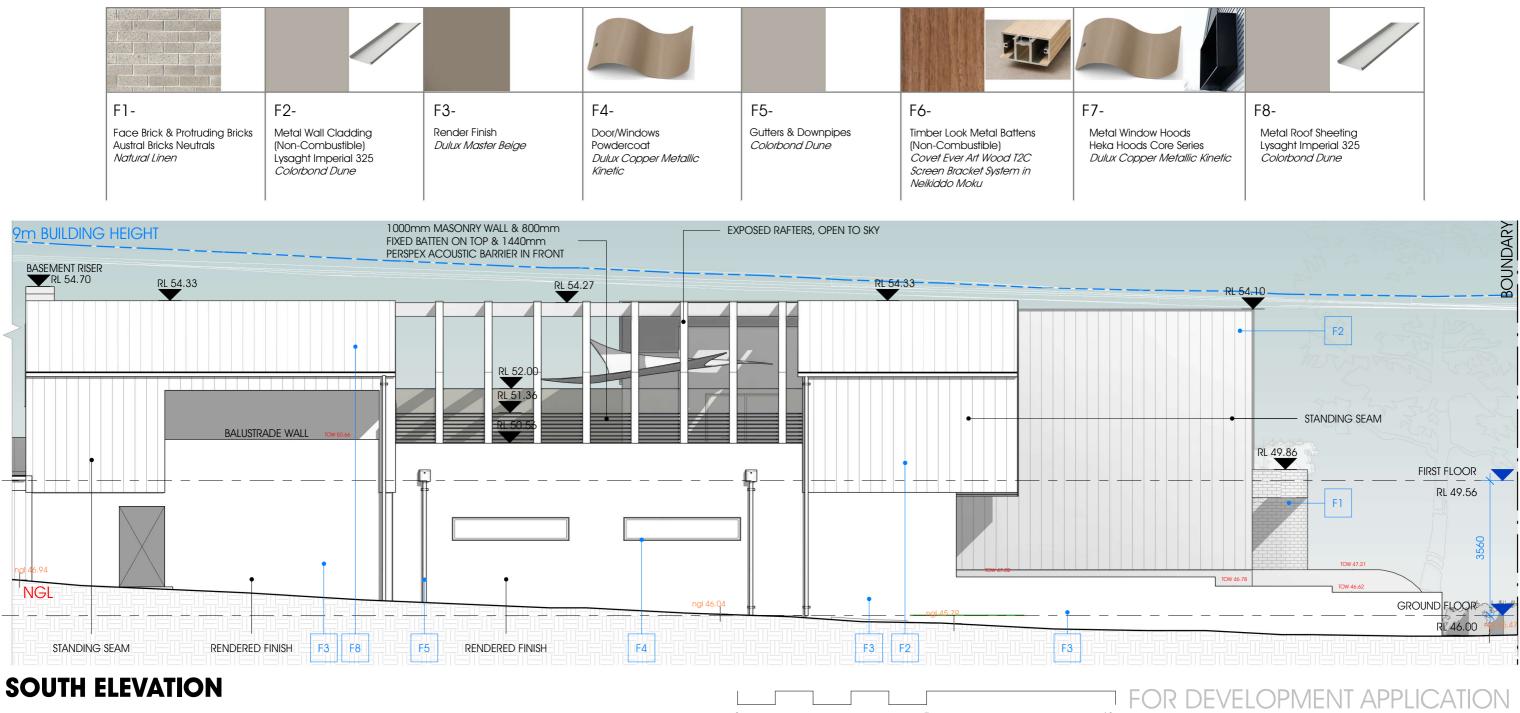
					E	
F1- Face Brick & Protruding Bricks Austral Bricks Neutrals <i>Natural Linen</i>	F2- Metal Wall Cladding (Non-Combustible) Lysaght Imperial 325 <i>Colorbond Dune</i>	F3- Render Finish <i>Dulux Master Beige</i>	F4- Door/Windows Powdercoat <i>Dulux Copper Metallic</i> <i>Kinetic</i>	F5- Gutters & Downpipes <i>Colorbond Dune</i>	F6- Timber Look Metal Battens (Non-Combustible) <i>Covet Ever Art Wood T2C</i> <i>Screen Bracket System in</i> <i>Neikiddo Moku</i>	F7- Metal Window Ho Heka Hoods Core <i>Dulux Copper Me</i>





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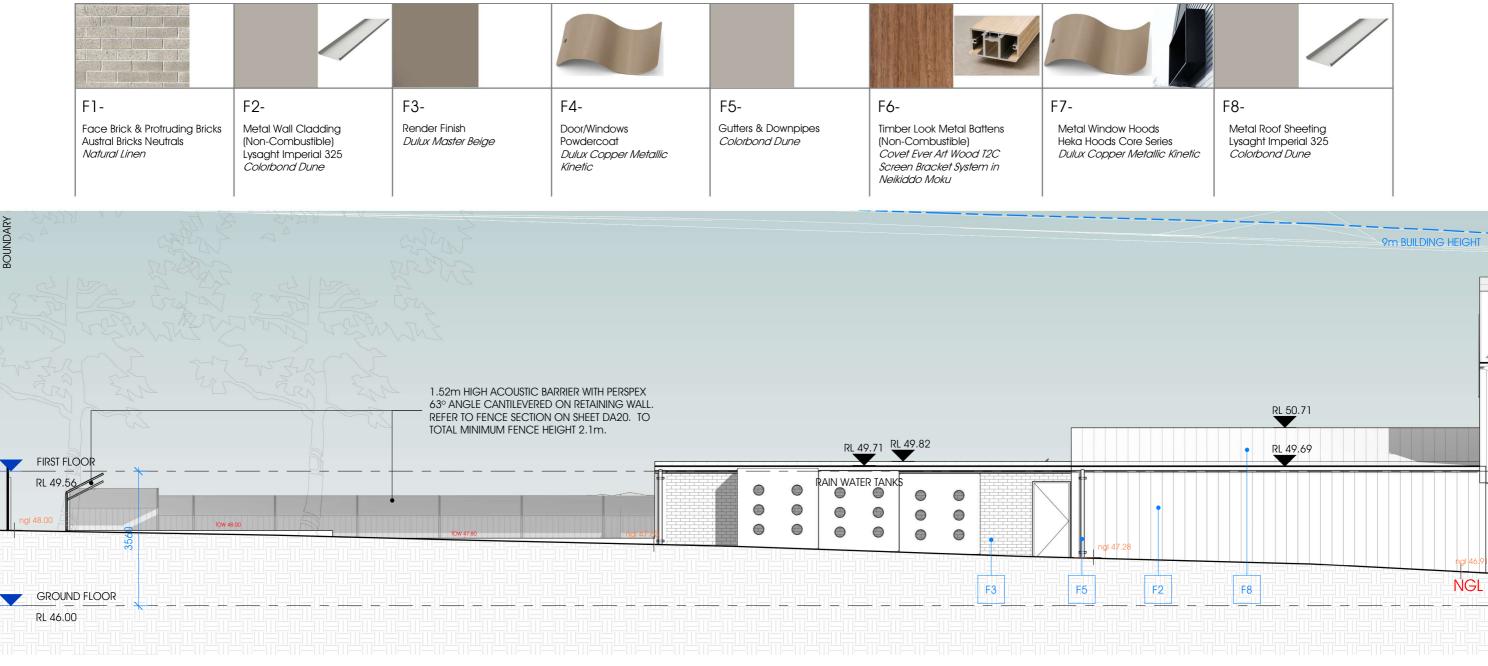








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#### **SOUTH ELEVATION**

BOUNDARY



#### **¬ FOR DEVELOPMENT APPLICATION**

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PROPOSED CHILDCARE CENTRE

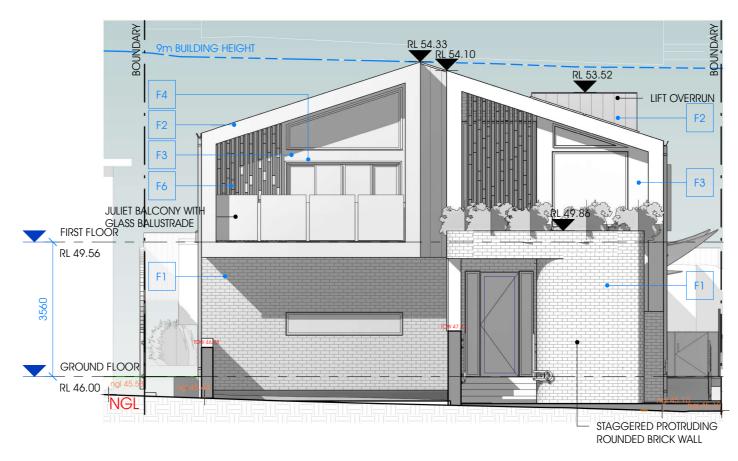


ADJACENT DWELLINGS 88 THE AVENUE SUBJECT SITE 86 THE AVENUE

ADJACENT DWELLING 84 THE AVENUE

#### **STREETSCAPE ELEVATION**

SCALE 1:200 (A3)



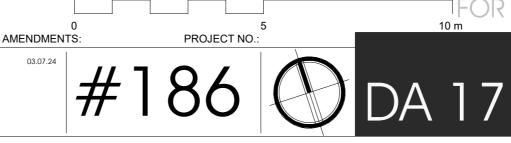
## EAST ELEVATION

SCALE 1:100 (A3)



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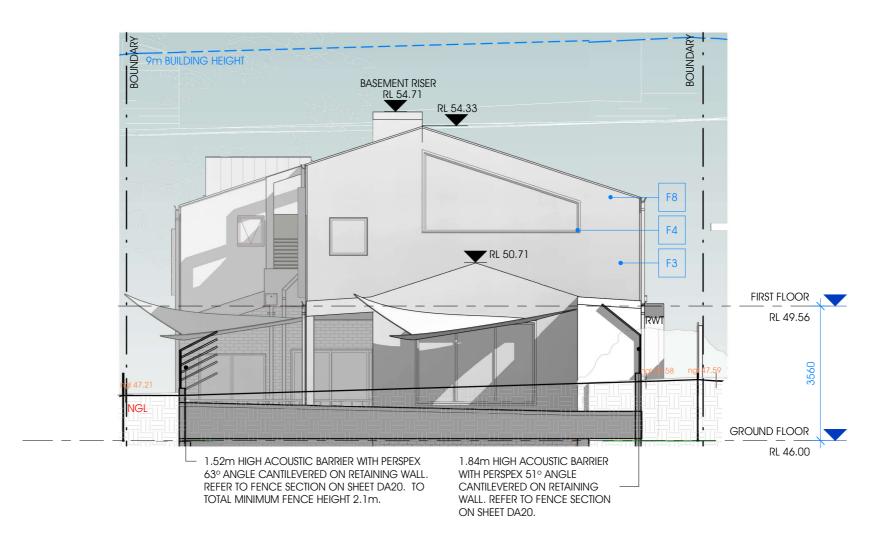




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PROPOSED CHILDCARE CENTRE



#### **WEST ELEVATION**

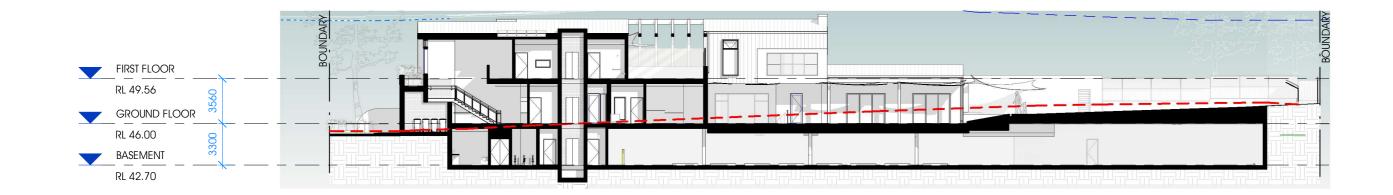
SCALE 1:100 (A3)

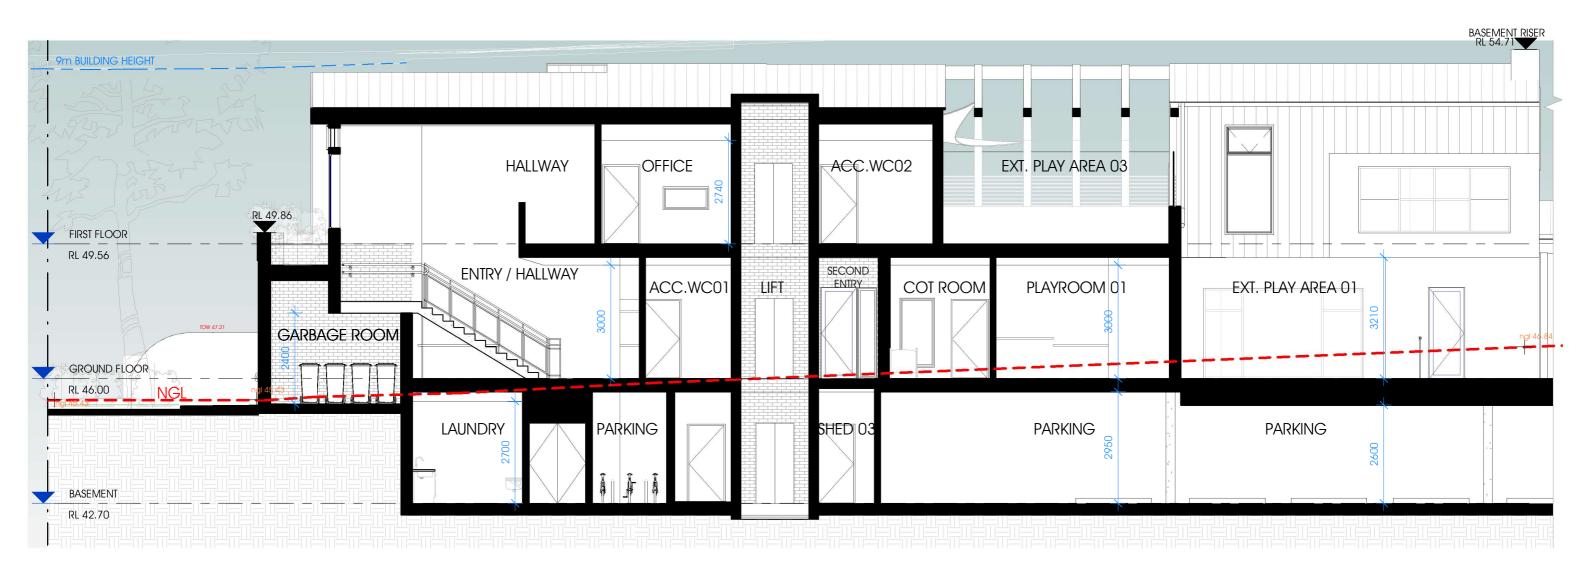


0 1 2m LOT 47, SEC. A, DP110163, 86 THE AVENUE, BANKSTOWN NSW 2200

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PROPOSED CHILDCARE CENTRE





#### **SECTION A-A**



#### FOR DEVELOPMENT APPLICATION

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PROPOSED CHILDCARE CENTRE



## **SECTION A-A**

SCALE 1:100 (A3)



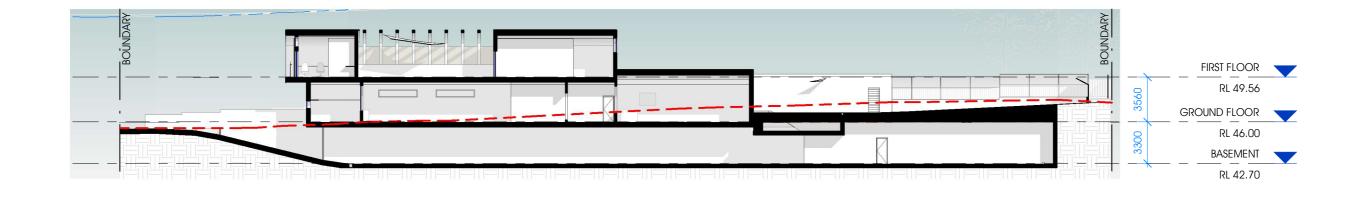
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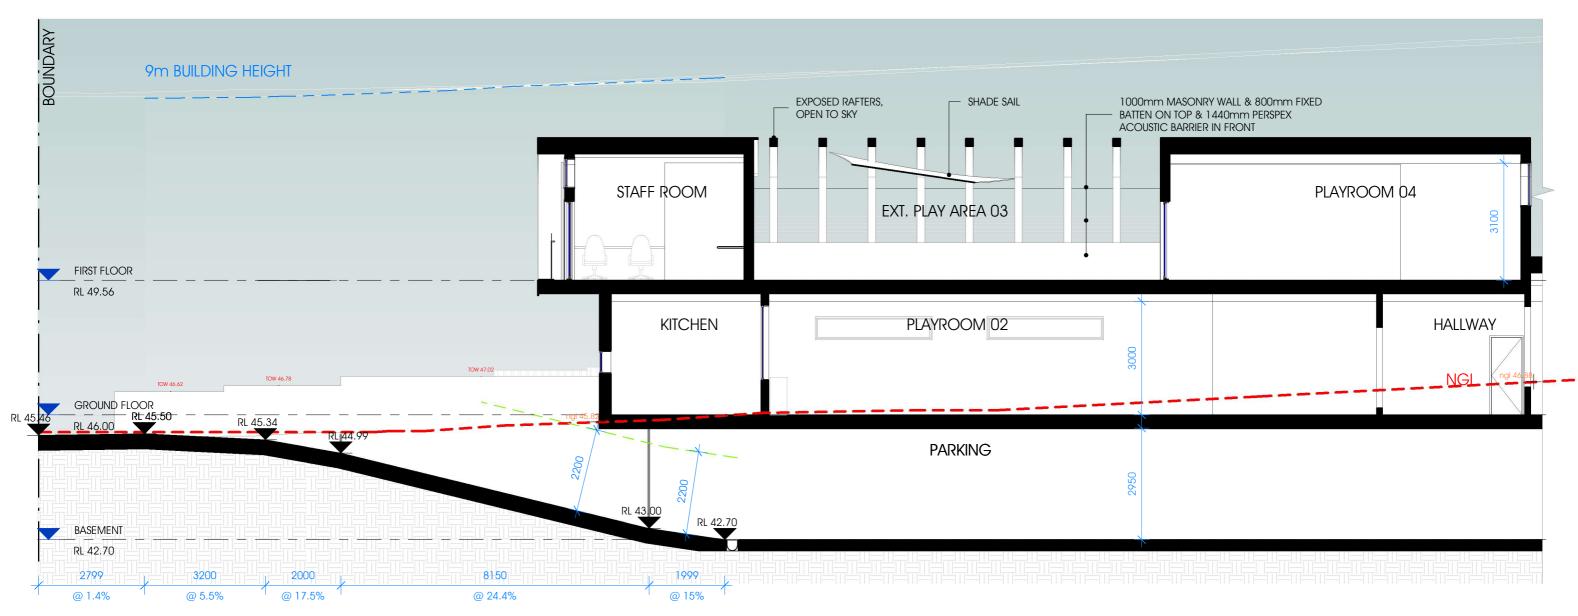




## FOR DEVELOPMENT APPLICATION

ENTITY 8886 PROPOSED CHILDCARE CENTRE





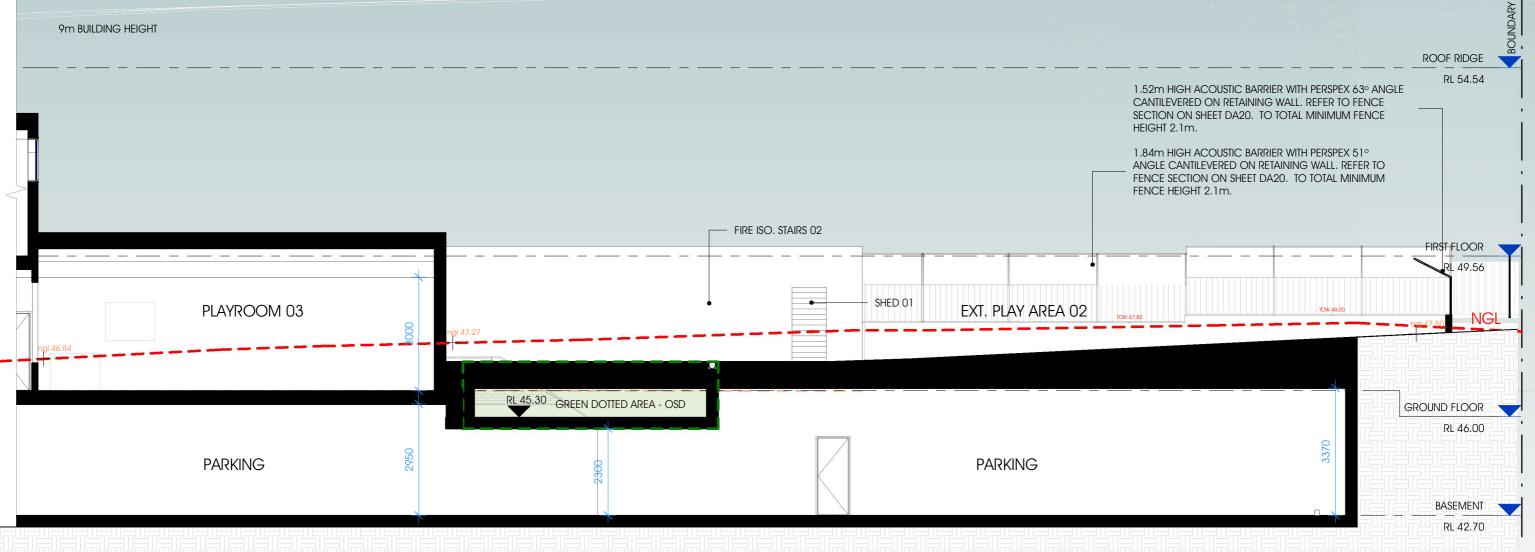
#### **SECTION B-B**



## FOR DEVELOPMENT APPLICATION

ENTITY 8886

PROPOSED CHILDCARE CENTRE



#### **SECTION B-B**



#### **¬** FOR DEVELOPMENT APPLICATION

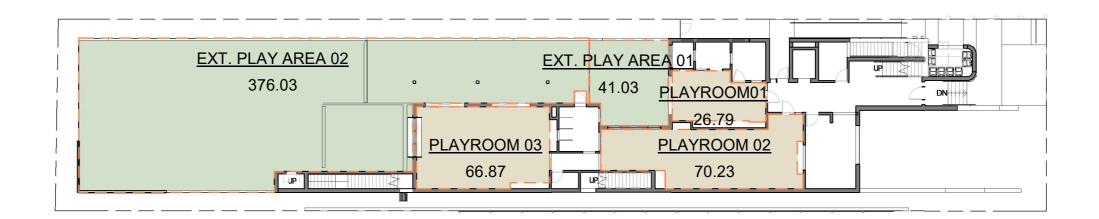
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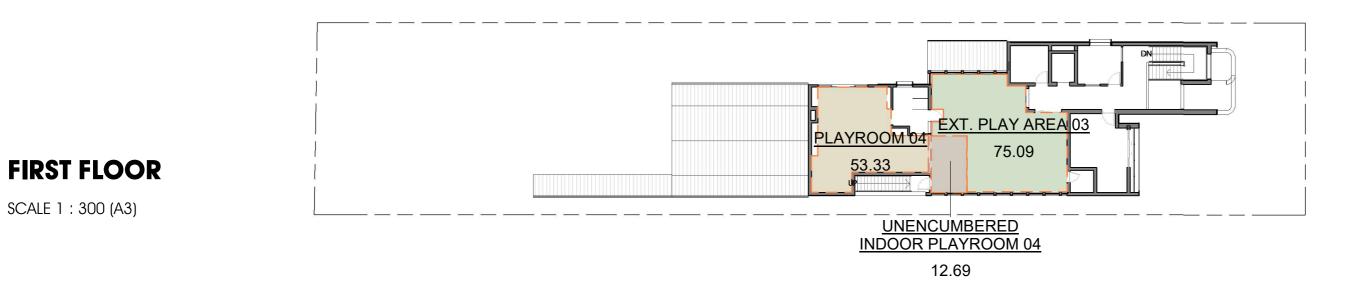
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PROPOSED CHILDCARE CENTRE



#### **GROUND FLOOR**

SCALE 1 : 300 (A3)



PLAYSPACE CALCULATION LEGEND	INTERNAL
INDOOR PLAYSPACE AREA	Name
	PLAYROOM 01
UNENCUMBERED INDOOR PLAYSPACE AREA	PLAYROOM 02
	PLAYROOM 03
OUTDOOR PLAYSPACE AREA	PLAYROOM 04

INTERNAL PLAYSPACE AREA SCHEDULE					
Name	Comments	Area Required	Area Provided	Staff Ratio	No. of Staff
PLAYROOM 01	8 - 0-2 YO	26	26.79 m <sup>2</sup>	1:4	2
PLAYROOM 02	20 - 3-6 YO	65	70.23 m <sup>2</sup>	1:10	2
PLAYROOM 03	20 - 3-6 YO	65	66.87 m <sup>2</sup>	1:10	2
PLAYROOM 04	20 - 2-3YO	65	53.33 m <sup>2</sup>	1:5	4
UNENCUMBERED INDOOR PLAYROOM 04			12.69 m <sup>2</sup>		
		221	229.92 m <sup>2</sup>		10

EXT. PLAY AREA EXT. PLAY AREA EXT. PLAY AREA

TOTAL



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PROJECT NO .:



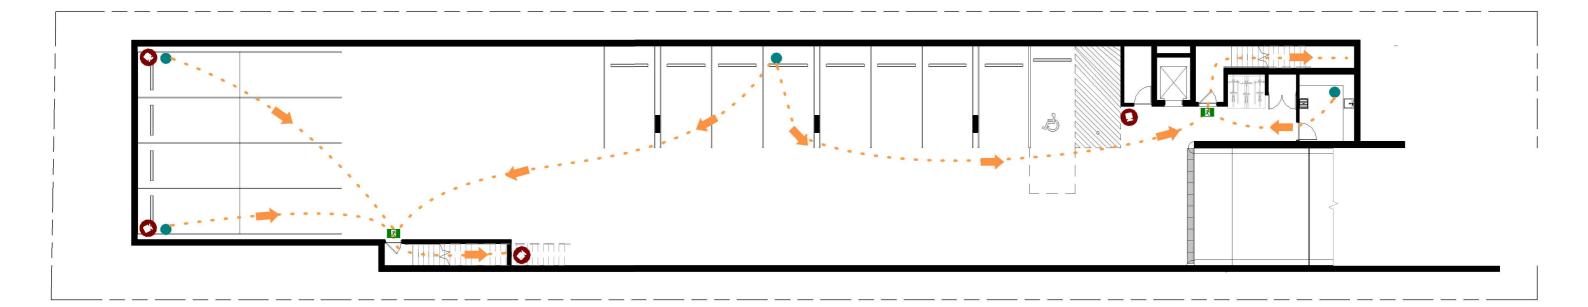
#### **EXTERNAL PLAYSPACE CALCS.**

<b>492.0</b> m	2
3 75m	12
2 376m	12
1 41m	12

## FOR DEVELOPMENT APPLICATION

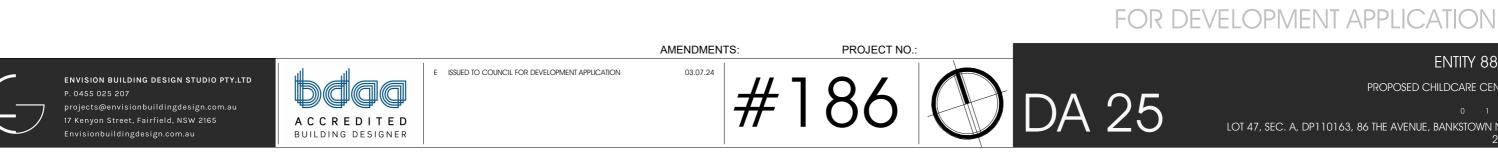
ENTITY 8886





#### **BASEMENT EVACUATION PLAN**

SCALE 1 : 200 (A3)

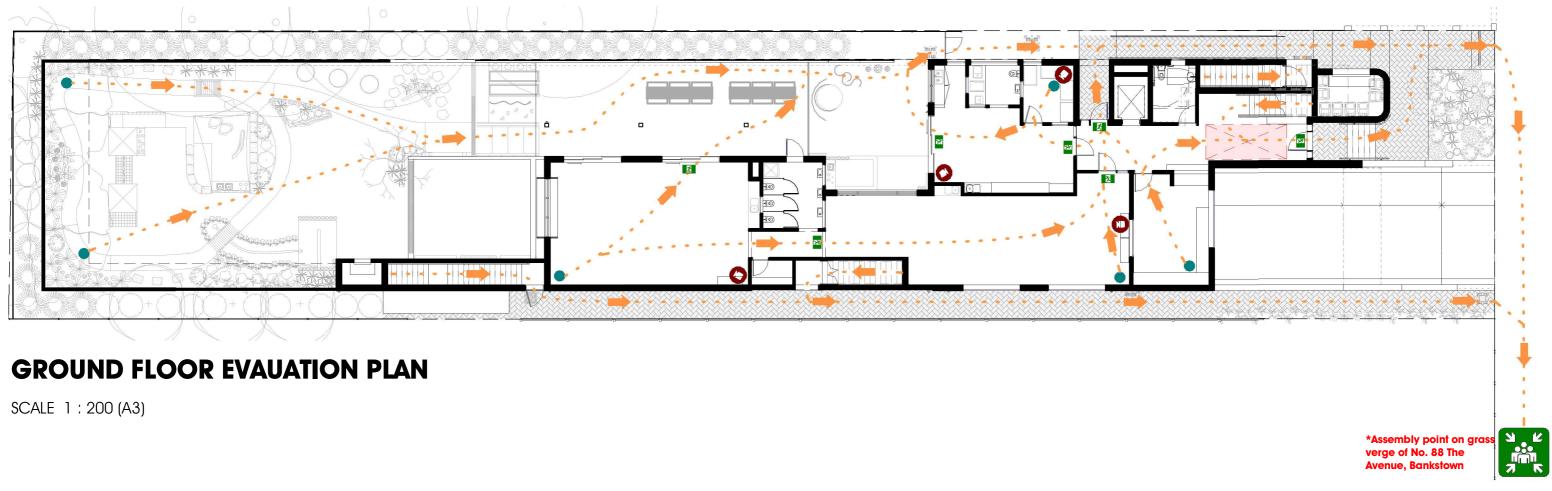


## ENTITY 8886

PROPOSED CHILDCARE CENTRE

SYMBOL	ITEM	SYMBOL	ITEM	NOTE:	
0	MOTION SENSOR WALL/POLE MOUNTED	0	CCTV CAMERAS	EMERGENCY	
	FLOODLIGHTS FOR CARPARK & EXTERNAL AREAS, COVERAGE WITH LUX SENSOR		EVACUATION TRAVEL PATHS	ACCORDANC	
	EMERGENCY ASSEMBLY POINT	2	FIRE EXITS	POLICIES	
		•	POINT LOCATION		
7	*ASSEMBLY POINT IN FRONT OF NO. 30 MINTO ROAD, MINTO		MUSTER LOCATION		

Y AND EVACUATION POLICY TO BE SETOUT IN NCE WITH AS 3745:2010 - PLANNING FOR CIES IN FACILITIES AND OTHER RELEVANT





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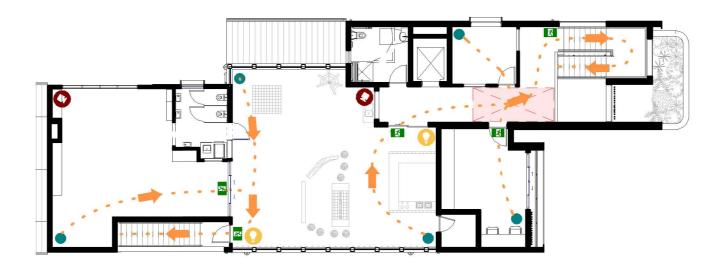
## FOR DEVELOPMENT APPLICATION

#### ENTITY 8886

PROPOSED CHILDCARE CENTRE

SYMBOL	ITEM	SYMBOL	ITEM	
0	MOTION SENSOR WALL/POLE MOUNTED	0	CCTV CAMERAS	EMERGENCY A
	FLOODLIGHTS FOR CARPARK & EXTERNAL AREAS, COVERAGE WITH LUX SENSOR		EVACUATION TRAVEL PATHS	ACCORDANCI
	EMERGENCY ASSEMBLY POINT	2	FIRE EXITS	POLICIES
		•	POINT LOCATION	
7 6	*ASSEMBLY POINT IN FRONT OF NO. 30 MINTO ROAD, MINTO		MUSTER LOCATION	

AND EVACUATION POLICY TO BE SETOUT IN ICE WITH AS 3745:2010 - PLANNING FOR IES IN FACILITIES AND OTHER RELEVANT



#### **FIRST FLOOR EVACUATION PLAN**

SCALE 1:200 (A3)



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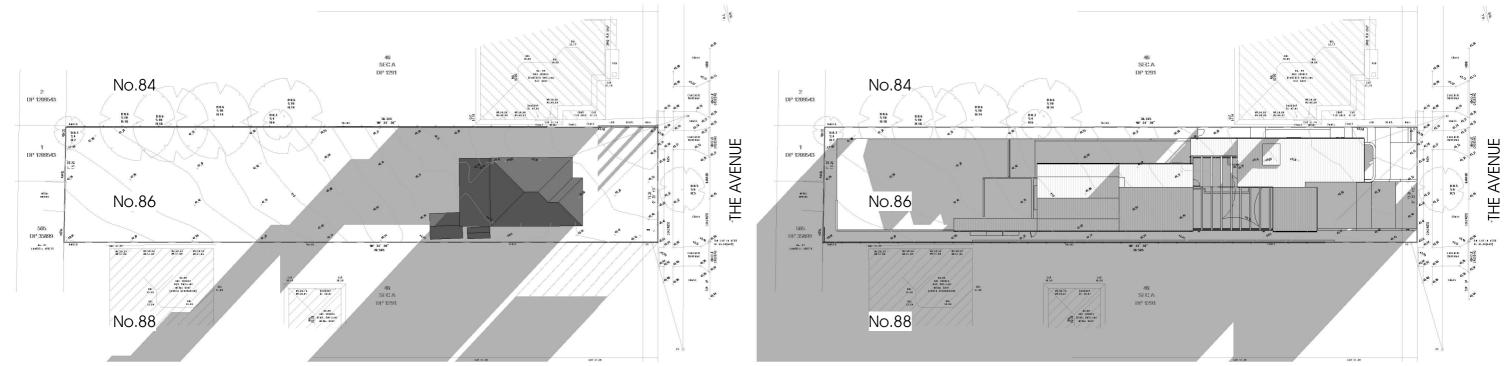


DA 27

#### FOR DEVELOPMENT APPLICATION

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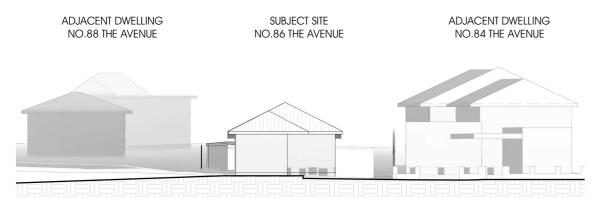
PROPOSED CHILDCARE CENTRE



#### EXISTING SHADOWS 8AM @ 21 JUNE

SCALE 1 : 500 (A3)

SCALE 1:500 (A3)



## **EXISTING ELEVATION SHADOWS 8AM @ 21 JUNE**

SCALE 1 : 300 (A3)



## **PROPOSED ELEVATION SHADOWS 8AM @ 21 JUNE**

SCALE 1 : 300 (A3)



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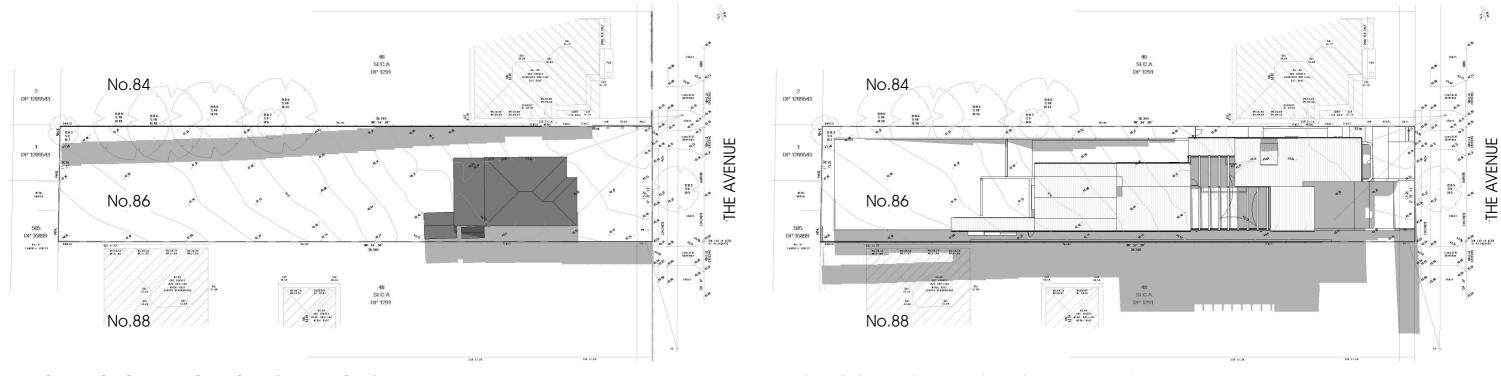
DA 28

#### ENTITY 8886

PROPOSED CHILDCARE CENTRE

## FOR DEVELOPMENT APPLICATION

## **PROPOSED SHADOWS 8AM @ 21 JUNE**

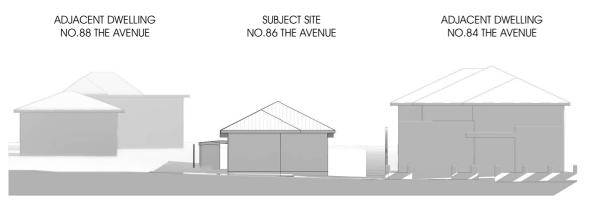


#### **EXISTING SHADOWS 12PM @ 21 JUNE**

SCALE 1:500 (A3)

**PROPOSED SHADOWS 12PM @ 21 JUNE** 

SCALE 1:500 (A3)



#### **EXISTING ELEVATION SHADOWS 12PM @ 21 JUNE**

SCALE 1 : 300 (A3)



#### **PROPOSED ELEVATION SHADOWS 12PM @ 21 JUNE**

SCALE 1 : 300 (A3)



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DA 29

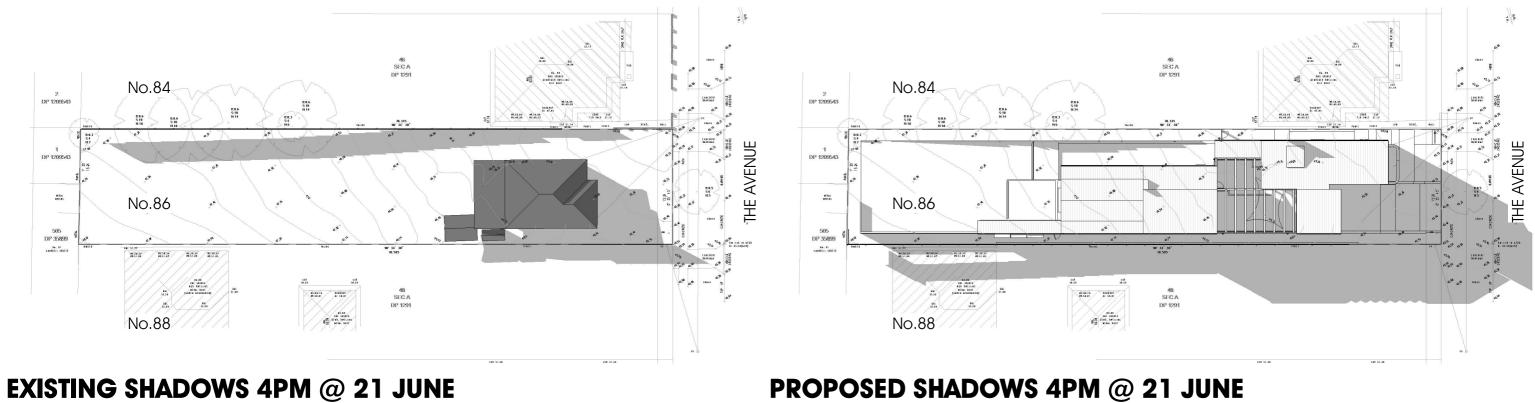


ENTITY 8886

PROPOSED CHILDCARE CENTRE

## FOR DEVELOPMENT APPLICATION

ADJACENT DWELLING



SCALE 1:500 (A3)

ADJACENT DWELLING SUBJECT SITE ADJACENT DWELLING NO.88 THE AVENUE NO.86 THE AVENUE NO.84 THE AVENUE

## **EXISTING ELEVATION SHADOWS 4PM @ 21 JUNE**

SCALE 1 : 300 (A3)

ADJACENT DWELLING SUBJECT SITE NO.88 THE AVENUE NO.86 THE AVENUE

## **PROPOSED ELEVATION SHADOWS 4PM @ 21 JUNE**

SCALE 1 : 300 (A3)

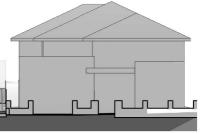
SCALE 1:500 (A3)



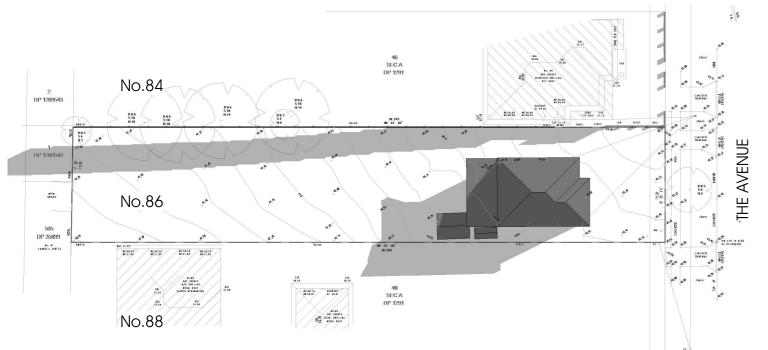
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PROPOSED CHILDCARE CENTRE

## FOR DEVELOPMENT APPLICATION

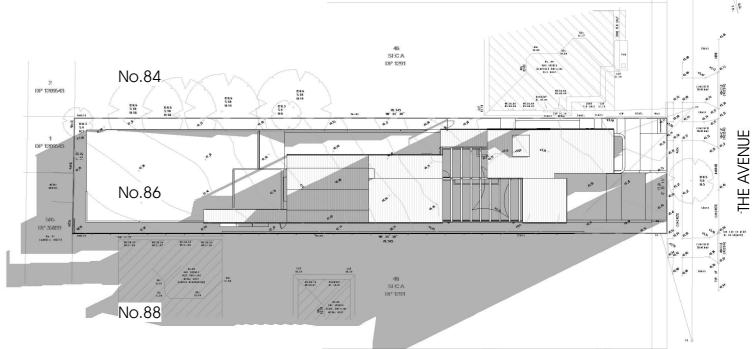


ADJACENT DWELLING NO.84 THE AVENUE



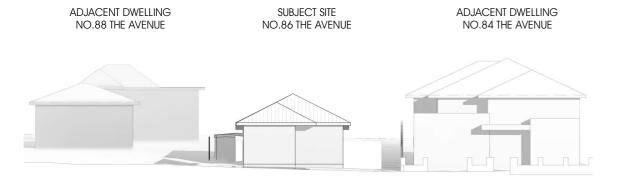


SCALE 1 : 500 (A3)



#### **PROPOSED SHADOWS 8AM EQUINOX**

SCALE 1 : 500 (A3)



## **EXISTING ELEVATION SHADOWS 8AM EQUINOX**

SCALE 1 : 300 (A3)



#### **PROPOSED ELEVATION SHADOWS 8AM EQUINOX**

SCALE 1 : 300 (A3)



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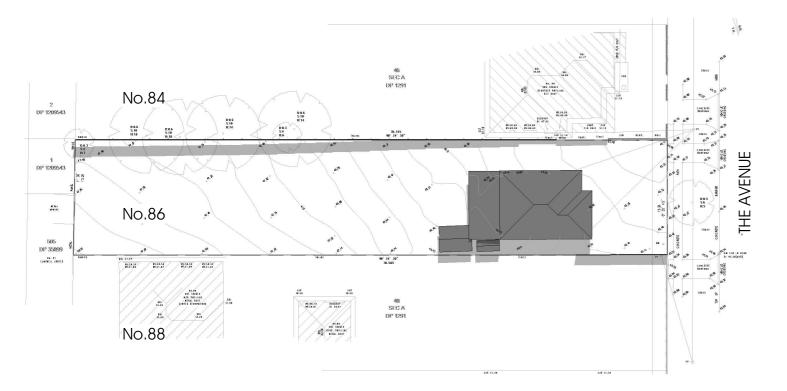
AMENDMENTS: PROJECT NO .: 03.07.24 #1 86

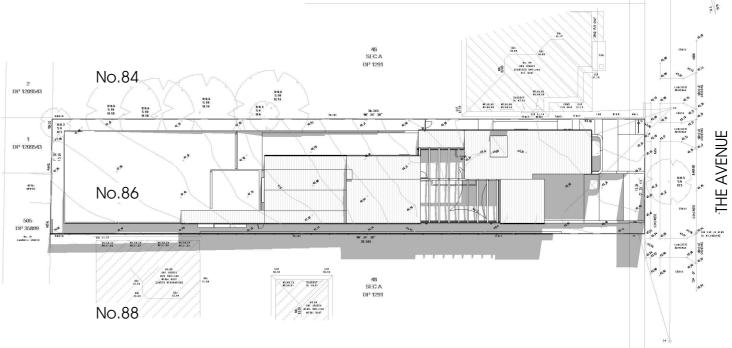


LOT 47, SEC. A, DP110163, 86 THE AVENUE, BANKSTOWN NSW 2200

ENTITY 8886

PROPOSED CHILDCARE CENTRE





#### **EXISTING SHADOWS 12PM EQUINOX**

SUBJECT SITE

NO.86 THE AVENUE

**EXISTING ELEVATION SHADOWS 12PM EQUINOX** 

SCALE 1:500 (A3)

ADJACENT DWELLING

NO.88 THE AVENUE

SCALE 1 : 300 (A3)

**PROPOSED SHADOWS 12PM EQUINOX** 

SCALE 1:500 (A3)



## **PROPOSED ELEVATION SHADOWS 12PM EQUINOX**

SCALE 1 : 300 (A3)



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ADJACENT DWELLING

NO.84 THE AVENUE

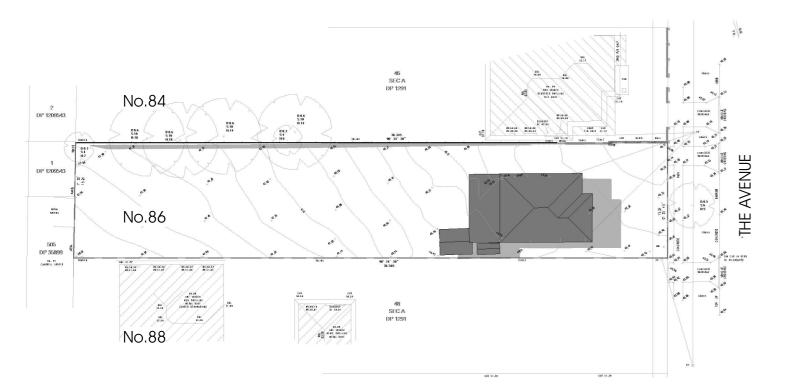
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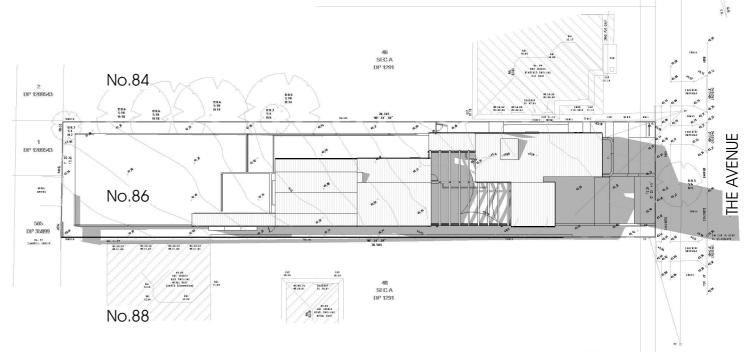
32



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PROPOSED CHILDCARE CENTRE



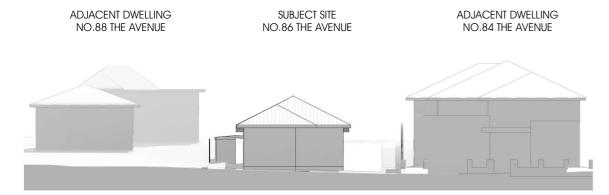


#### **PROPOSED SHADOWS 4PM EQUINOX**

SCALE 1:500 (A3)



SCALE 1:500 (A3)



## **EXISTING ELEVATION SHADOWS 4PM EQUINOX**

SCALE 1 : 300 (A3)



## **PROPOSED ELEVATION SHADOWS 4PM EQUINOX**

SCALE 1 : 300 (A3)



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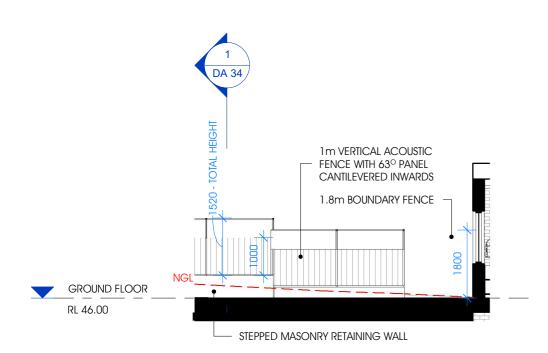




LOT 47, SEC. A, DP110163, 86 THE AVENUE, BANKSTOWN NSW 2200

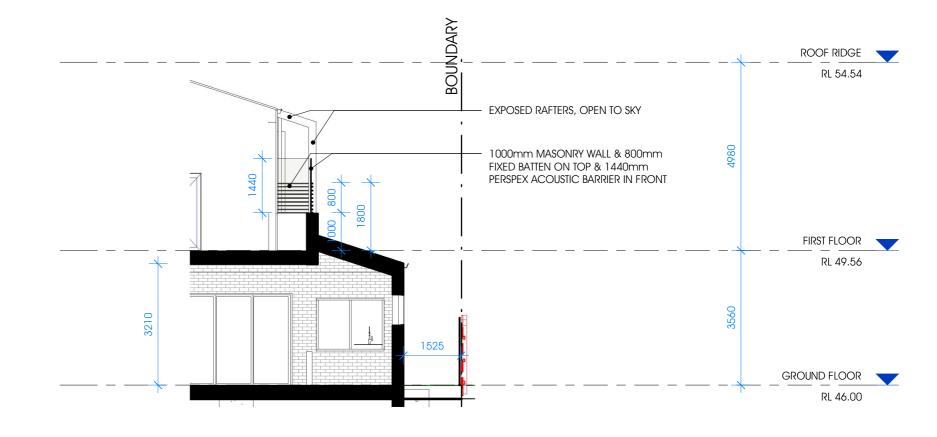
ENTITY 8886

PROPOSED CHILDCARE CENTRE



## **GROUND FLOOR - NORTHERN FENCE DETAIL**

SCALE 1:100 (A3)



#### **FIRST FLOOR - BARRIER SECTION DETAIL**

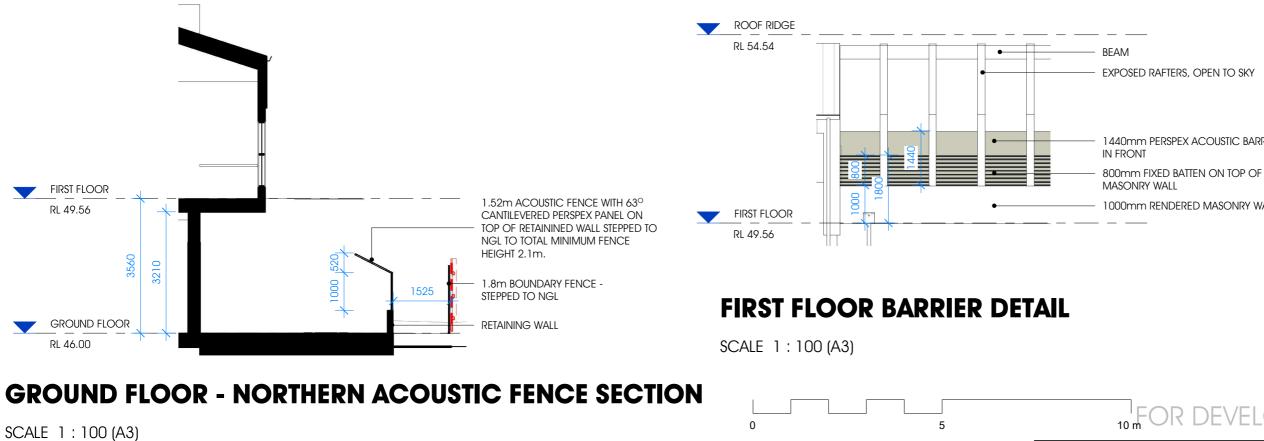
PROJECT NO .:

SCALE 1:100 (A3)

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1440mm PERSPEX ACOUSTIC BARRIER

1000mm RENDERED MASONRY WALL

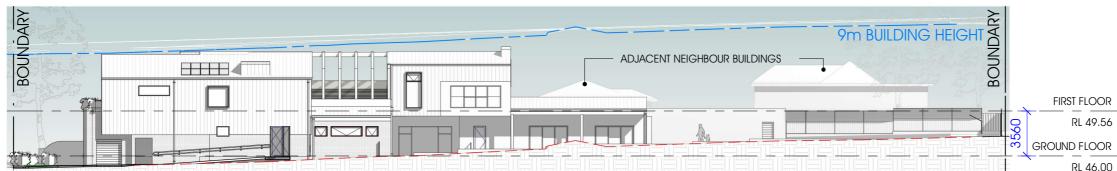
#### **ACOUSTIC RECOMMENDATIONS**

 1.44m HIGH ACOUSTIC BARRIER
 1.52m High Acoustic Barrier - 1.0 Vertical Barrier With 1.1m Cantilevered inwards at 63° angle
 1.84m HIGH ACOUSTIC BARRIER - 1.0m VERTICAL BARRIER WITH 1.3m CANTILIVERED INWARDS AT 51° ANGLE

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PROPOSED CHILDCARE CENTRE



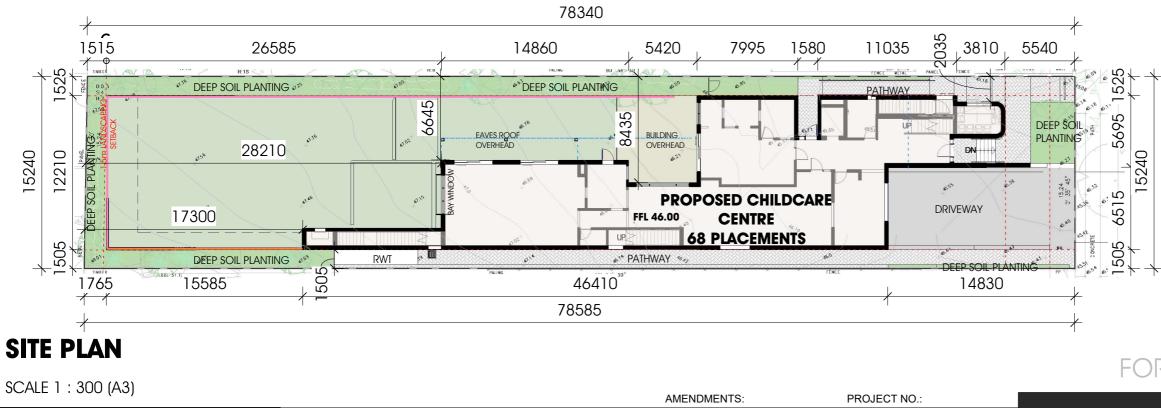
## **NORTH ELEVATION**

SCALE 1 : 300 (A3)



## **SOUTH ELEVATION**

SCALE 1 : 300 (A3)



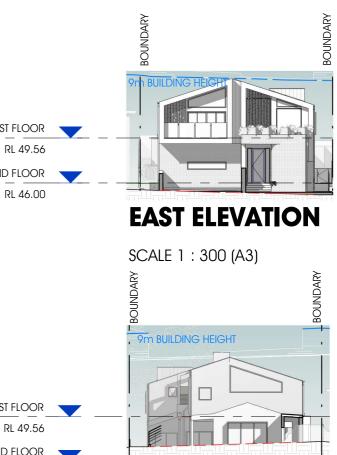
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**WEST ELEVATION** 

SCALE 1 : 300 (A3)

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